
- 1. TEMPORARY BENCHMARK BASED ON A CITY APPROVED BENCHMARK AS SHOWN ON THESE
- 2. ALL EXISTING ELEVATIONS SHALL BE FIELD VERIFIED BY CONTRACTOR UNLESS OTHERWISE
- ALL SURVEY MONUMENTS SHALL BE REPLACED IF DAMAGED BY CONTRACTOR AT CONTRACTOR'S EXPENSE.
- 4. CONTRACTOR SHALL NOT DESTROY EXISTING PERMANENT SURVEY MONUMENTS. 5. ALL WORK SHALL CONFORM TO THE LATEST EDITION OF THE CITY OF MORGAN HILL STANDARD DETAILS FOR CONSTRUCTION WHICH ARE HEREBY MADE A PART OF THESE PLANS. DEVIATIONS FROM THE STANDARD DETAILS MUST BE APPROVED BY THE CITY ENGINEER.
- 6. A NO FEE ENCROACHMENT PERMIT SHALL BE OBTAINED FROM THE PUBLIC WORKS DEPARTMENT UPON COMPLETION OF PRE-CONSTRUCTION MEETING AND PRIOR TO CONSTRUCTION OF ANY IMPROVEMENTS.
- 7. NOT USED. 8. CONTRACTOR SHALL NOTIFY THE PUBLIC WORKS DEPARTMENT 48 HOURS PRIOR TO COMMENCEMENT OF ANY WORK PHASE. AT THAT TIME AN "INSPECTION REQUEST FORM" SHALL BE COMPLETED TO ENSURE PROPER SCHEDULING OF AN INSPECTION WITH THE CITY ENGINEER'S REPRESENTATIVE.
- 9. CONTRACTOR SHALL PRESERVE ALL SURROUNDING PROERTY BY CONFINING OPERATIONS TO WITHIN THE "LIMITS OF WORK". CONTRACTOR SHALL BE RESPONSIBLE FOR MAINTAINING ACCESS FOR ALL ADJOINING RESIDENTS, PLACES OF BUSINESS, AND PROPERTIES AND PROVIDING WRITTEN NOTICE AT LEAST 24 HOURS IN ADVANCE OF ANY INTERRUPTION IN ACCESS OR SERVICE
- TO THE ABOVE PROPERTY OWNERS AS WELL AS TO THE CITY ENGINEER'S REPRESENTATIVE. 10. CONTRACTOR SHALL ONLY USE EQUIPMENT PROVIDED WITH A SPARK ARRESTOR DEVICE TO REDUCE A POTENTIAL FIRE HAZARD.
- 11. NOT USED.
- 12. OFF-SITE WATER & DUST CONTROL: CONTRACTOR SHALL PROVIDE A WATER TRUCK/STREET SWEEPER ON-SITE AT ALL TIMES. CONTRACTOR WILL BE ALLOWED TO DRAW WATER FROM THE CITY OF MORGAN HILL WATER DISTRIBUTION SYSTEM ONLY AFTER OBTAINING A HYDRANT METER FROM THE PUBLIC WORKS DEPARTMENT AND AN INSPECTION OF THE WATER TRUCK FOR A PROPER BACKFLOW DEVICE OR "AIR-GAP" FILLING PIPE. CONTRACTOR SHALL KEEP DOWN DUST FROM CONSTRUCTION ACTIVITY TO THE MAXIMUM EVENT POSSIBLE. CONTRACTOR SHALL CLEAN ALL EXISTING STREETS, CURBS, GUTTERS, AND SIDEWALKS AFFECTED BY THE PROJECT AT THE END OF EACH WORKING DAY.
- 3. MATERIAL STORAGE: NO MATERIAL SHALL BE STORED NEAR THE EDGE OF PAVEMENT, TRAVELED WAY, SIDEWALK. DRIVEWAY, OR SHOULDER LINE WHICH MAY CREATE A HAZARD FOR VEHICULAR AND PEDESTRIAN TRAFFIC. CONTRACTOR IS RESPONSIBLE FOR SECURING A STORAGE AREA NEAR THE PROJECT.
- 4. TRAFFIC CONTROL CONTRACTOR SHALL SUBMIT A TRAFFIC CONTROL PLAN FOR APPROVAL TO THE PUBLIC WORKS DEPARTMENT A MINIMUM OF 10 DAYS PRIOR TO ANY WORK WITHIN AN EXISTING PUBLIC STREET. THE PLAN SHALL BE SIGNED BY A LICENSED TRAFFIC ENGINEER WHEN IT INVOLVES AN ARTERIAL STREET. CONTRACTOR SHALL PROVIDE ALL NECESSARY TRAFFIC CONTROL IN ACCORDANCE WITH THE LATEST EDITION OF A CALTRANS "MANUAL OF WARNING SIGNS, LIGHTS, AND DEVICES FOR USE IN PERFORMANCE OF WORK UPON HIGHWAYS". WHILE WORKING WITHIN THE PUBLIC RIGHT-OF-WAY. TWO TRAFFIC LANES (10' MIN.) SHALL BE OPEN TO VEHICULAR TRAFFIC DURING ALL HOURS, WEEKENDS, AND HOLIDAYS. ONE LANE ONE WAY TRAFFIC, MAY BE PERMITTED UNDER THE CONTROL OF NOT LESS THAN 2 (TWO) COMPETENT FLAGMEN DURING CONSTRUCTION OPERATIONS. STREET CLOSURES AND DETOURS SHALL ONLY TAKE PLACE UPON CITY ENGINEER APPROVAL AND POLICE DEPARTMENT COORDINATION.
- TRENCH EXCAVATION: CONTRACTOR SHALL EXERCISE DILIGENCE IN REVIEWING THE SOILS REPORT AND OTHER AVAILABLE RESOURCES TO FAMILIARIZE HIMSELF/ HERSELF WITH THE SOIL CONDITIONS TO BE ENCOUNTERED IN THE COURSE OF WORK IDENTIFIED IN THESE PLANS. CONTRACTOR SHALL NOT CAUSE DAMAGE TO ADJACENT TREES OR EXISTING STRUCTURES ABOVE OR BELOW GRADE DURING TRENCH EXCAVATION. ALL ROCKS, BOULDERS, AND LARGE STONES ENCOUNTERED SHALL BE REMOVED TO PROVIDE A CLEARANCE OF 6 INCHES AROUND THE PIPE. THE TRENCH BOTTOM SHALL BE REFILLED TO GRADE WITH SAND, PEA GRAVEL. OR OTHER APPROVED GRANULAR MATERIAL. CLEAN 1/2 " OR 1/2 " PEA GRAVEL SHALL BE USED IN AREAS OF MOIST CONDITION OR WHERE THE SOIL HAS A HISTORY OF SUBSURFACE WATER. IF THE BOTTOM OF THE TRENCH IS FOUND TO CONSIST OF WET OR UNSTABLE MATERIAL INCAPABLE OF PROPERLY SUPPORTING THE PIPE, THE MATERIAL SHALL BE REMOVED TO A MINIMUM DEPTH OF 12 INCHES BELOW THE UNSTABLE LAYER FOR THE FULL WIDTH OF THE TRENCH AND REPLACED WITH APPROVED GRANULAR MATERIAL. TRENCH EXCAVATION MATERIAL DEPOSITED ADJACENT TO THE TRENCH SHALL BE PLACED AND LOCATED TO PREVENT SPILLAGE INTO THE OPEN TRENCH.
- TRENCH SAFETY: IT SHALL BE CONTRACTOR'S RESPONSIBILITY TO PROVIDE ALL NECESSARY TRENCH SAFETY MEASURES FOR EXCAVATIONS. ALL TRENCH SAFETY MEASURES SHALL BE IN ACCORDANCE WITH THE LATEST CAL-OSHA GUIDELINES. CONTRACTOR SHALL PROVIDE EVIDENCE OF A CAL-OSHA TRENCHING PERMIT AT THE PRE-CONSTRUCTION MEETING. CONTRACTOR SHALL
- PROVIDE SITE SPECIFIC TRENCH SAFETY PLAN FOR CITY REVIEW AND APPROVAL. 17. EXCAVATIONS WITHIN THE PUBLIC RIGHT-OF-WAY SHALL BE BACKFILLED, COMPACTED, AND TEMPORARILY PAVED WITH COLD MIX "CUT BACK" TYPE A.C. TO ALLOW FOR VEHICULAR AND PEDESTRIAN TRAFFIC PRIOR TO 4:00 P.M. THE USE OF TRENCH PLATES IS ALLOWED. PROVIDED THE CONTRACTOR RECESSES THE PLATES.
- IT SHALL BE THE CONTRACTORS' RESPONSIBILITY TO MAINTAIN ON A DAILY BASIS, INCLUDING WEEKENDS, THE AMOUNT OF MATERIAL NECESSARY TO MAINTAIN THE TRENCH SURFACE FLUSH WITH THE EXISTING STREET OR SIDEWALK. IN ADDITION, THE CONTRACTOR SHALL RESPOND TO AND CORRECT SHIFTING TRENCH PLATES REGARDLESS OF THE TIME OF DAY. IF CONTRACTOR FAILS TO CORRECT SINKING BACKFILL MATERIAL OR SHIFTING TRENCH PLATES IN A TIMELY MANNER, CITY SHALL RESERVE THE RIGHT TO CORRECT THE PROBLEM AND BACK CHARGE THE CONTRACTOR.
- 8. JOINING EXISTING PAVEMENT: EXISTING PAVEMENT WHICH IS TO BE JOINED BY NEW PAVEMENT SHALL BE SAW CUT VERTICAL TO PROVIDE STRAIGHT, TRUE, AND NEAT JOINTS. OVERLAPPING OF EXISTING PAVEMENT WITHOUT SAW CUTTING OR GRINDING SHALL NOT BE PERMITTED. THE VERTICAL EDGES SHALL BE TACKED PRIOR TO PAVING. TERMINALS OF ALL SURFACING INDICATED ON THE PLANS SHALL JOIN ANY EXISTING SURFACE IN A SMOOTH BUTT JOINT, CONFORM PAVING BY METHOD OF ABRASIVE GRINDING WILL BE ALLOWED UPON APPROVAL OF THE CITY
- SANITARY SEWERS: 19. ALL MANHOLES, SEWER MAINS, AND LATERALS MUST PASS A LEAKAGE TEST AS DESCRIBED IN THE CITY OF MORGAN HILL STANDARD DETAILS FOR CONSTRUCTION. AFTER ALL BACKFILL, TESTING, AND PAVEMENT RESTORATION HAS BEEN COMPLETED. THE CONTRACTOR SHALL FLUSH AND CLEAN ALL SEWER LINES 24 INCHES OR LESS IN DIAMETER BY THE "WAYNE BALL METHOD". AFTER THE LEAKAGE TEST, BUT PRIOR TO PAVING, A TELEVISION INSPECTION SHALL BE PERFORMED AT ALL LOCATIONS OF NEWLY INSTALLED SEWER MAINS AT CONTRACTOR'S EXPENSE. THE UNDERGROUND CONTRACTOR MUST KEEP

AN ACCURATE RECORD OF MANHOLES AND THE DISTANCE BETWEEN THEM AND EACH WYE


20. BEFORE ANY SEWERS ARE CONSTRUCTED, THE CONTRACTOR SHALL VERIFY THE ELEVATION AND LOCATION OF EXISTING SEWER LATERALS BY FILMING THE EXISTING LINE. EXISTING SEWER LATERALS FROM THE NORTH AND SOUTH SHALL BE CONNECTED TO THE NEW LINE. 21. THE END OF EACH NEW LATERAL SHALL BE MARKED AS SHOWN IN DETAIL S-2. THE CONCRETE CONTRACTOR SHALL STAMP AN "S" ON THE FACE OF CURB DIRECTLY ABOVE THE

BRANCH LATAERAL, AND THEIR DIRECTION.

IMPROVEMENT PLANS FOR TENNANT AVENUE SEWER MAIN PROJECT

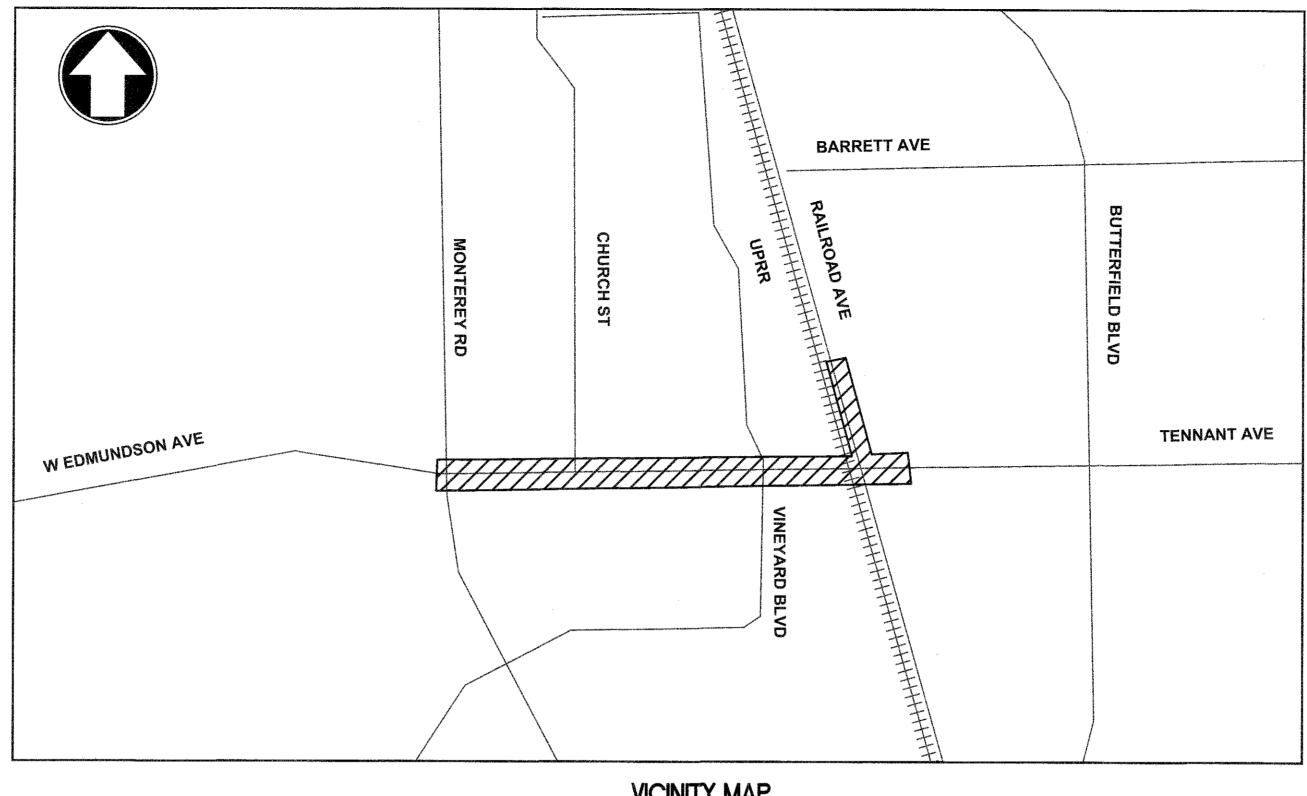

VICINITY MAP

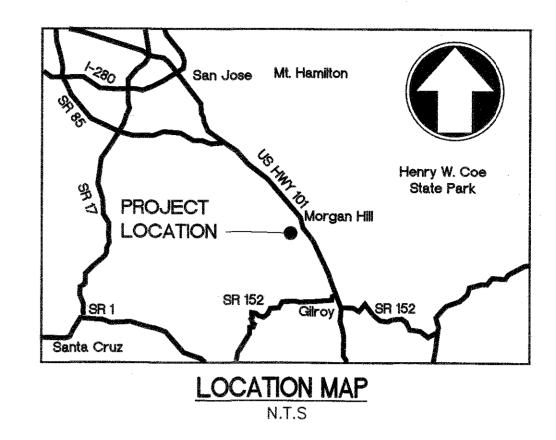

INDEX OF SHEETS

TC-4

INDEX OF SHEETS				
Sheet No.	Description	Station		
G-1 G-2 G-3	TITLE, INDEX, ABBREVIATIONS, AND LEGEND PROJECT NOTES KEY MAP			
G-4 C-1 C-2 C-3	SURVEY CONTROL PLAN AND PROFILE PLAN AND PROFILE	STA 200+00 TO 204+60 STA 204+60 TO 210+70		
C-3 C-4 C-5 C-6	PLAN AND PROFILE PLAN AND PROFILE PLAN AND PROFILE TUNNEL CROSSING	STA 210+70 TO 217+00 STA 217+00 TO 222+50 STA 222+50 TO 223+47		
C-7	RAILROAD AVE TO TENNANT AVE SUGGESTED BYPASS PUMPING PLAN			
D-1 D-2 D-3	DETAILS DETAILS CITY STANDARD DETAILS			
TC-0	TRAFFIC CONTROL PLAN			

TRAFFIC CONTROL PLAN

TRAFFIC CONTROL PLAN


TRAFFIC CONTROL PLAN

TRAFFIC CONTROL PLAN

- 22. CONTRACTOR SHALL NOT TURN OFF OR ON ANY VALVES BELONGING TO THE CITY'S WATER SYSTEM. ONLY DEPARTMENT OF PUBLIC WORKS PERSONNEL SHALL OPEN THE NECESSARY VALVES TO CONNECT NEW LINES. FAILURE TO FOLLOW THIS REQUIREMENT SHALL BE CONSIDERED AN "UNLAWFUL CONNECTION" AND MAY RESULT IN ISSUING OF A CITATION AND FINES AS SPECIFIED IN SECTION 13.04 OF THE MORGAN HILL MUNICIPAL CODE.
- 23. CONNECTIONS REQUIRING SHUT DOWN OF THE SYSTEM SHALL BE DONE BETWEEN THE HOURS OF 12:00 MIDNIGHT AND 6:00 A.M., AND ONLY UPON COORDINATION WITH THE DEPARTMENT OF PUBLIC WORKS. 24. ALL WATER LINES SHALL BE TESTED AFTER COMPLETION OF THE TRENCH BACKFILL AND
- COMPACTION OF THE FINAL BASE MATERIAL, BUT PRIOR TO THE PLACEMENT OF THE FINAL ROADWAY SURFACE.
- 25. THE CONCRETE CONTRACTOR SHALL STAMP A LETTER "W" ON THE FACE OF CURB DIRECTLY ABOVE THE WATER SERVICE.
- 26. FIRE HYDRANT WET BARREL TYPE, CAST IRON BODY, TWO 2 1/2" OUTLETS AND ONE 4 1/2" OUTLET, CLOW MODEL F-960 WITH CLOW #40 BREAKOFF CHECK VALVE ASSEMBLY OR EQUAL.
- 27. BACKFILL MATERIAL SHALL BE HAND PLACED AND COMPACTED UP TO AT LEAST 6" ABOVE THE PIPE. WHEN USING NATIVE SOILS AS TRENCH BACKFILL, THE MINIMUM SAND COVER
- 28. JETTING AND/OR FLOODING OF TRENCH BACKFILL MATERIAL WILL BE PERMITTED ONLY IF APPROVED BY THE SOILS ENGINEER AND CITY ENGINEER.
- 29. ANY EXCESS EXCAVATION MATERIAL MAY BE DEPOSITED ON-SITE IN AREAS AND AT DEPTHS DESIGNATED BY THE OWNER AND WITH APPROVAL OF THE CITY ENGINEER. 30. THE MINIMUM RELATIVE COMPACTION FOR TRENCH BACKFILL, SUBGRADE AND BASE MATERIAL SHALL BE 95% THROUGHOUT THE PROJECT UNLESS RECOMMENDED OTHERWISE
- IN THE SOILS REPORT AND APPROVED BY THE CITY ENGINEER. 31. IF TRENCH BACKFILL MATERIAL IS 100% AB, THE CITY ENGINEER SHALL CONDUCT
- COMPACTION TESTS OF THE LIFTS SPECIFIED.
- 32. ANY AGGREGATE BASE THAT BECOMES CONTAMINATED DURING CONSTRUCTION SHALL BE REMOVED AND REPLACED WITH UNCONTAMINATED BASE. 33. EROSION CONTROL:
- AN EROSION AND SEDIMENT CONTROL PLAN SHALL BE REQUIRED PRIOR TO AND ANY PHYSICAL DEVELOPMENT OF A PROPERTY. EROSION CONTROL SHALL BE PLANNED BETWEEN OCTOBER 15TH AND MAY 1ST, AND SEDIMENT CONTROL SHALL BE PLANNED YEAR ROUND FOR THE LIFE OF THE PROJECT. SAID PLANS SHALL MEET THE MINIMUM STANDARDS AND SPECIFICATIONS OF THE CALIFORNIA STORMWATER QUALITY ASSOCIATION (CASQA) FOR STORM WATER BEST MANAGEMENT PRACTICES (BMPs). CONTRACTOR SHALL BE RESPONSIBLE FOR INITIATING THE REQUIRED CONTROL MEASURES. CASQA BMP INFORMATION CAN BE VIEWED AND DOWNLOADED AT http://cabmphanbooks.com/Construction/asp.
- 34. CURB INLET STENCILING: ALL CURB INLETS SHALL HAVE THERMOPLASTIC STENCILING: "NO DUMPING, FLOWS TO CREEK/RIVER".
- 35. NOT USED.

THE STANDARD SPECIFICATIONS AND DETAILS, LATEST EDITION, OF THE CITY OF MORGAN HILL SHALL GOVERN UNLESS OTHERWISE SPECIFIED HEREIN.

Contractor agrees that he shall assume sole and complete responsibility for job site conditions during the course of construction of this project, including safety of all persons and property; that this requirement shall apply continuously and not be limited to normal working hours; and that the Contractor shall defend, indemnify, and hold the Owner and the Engineer harmless from any and all liability, real or alleged, in connection with the performance of work on this Project, excepting for liability arising from the sole negligence of the Owner or the Engineer.

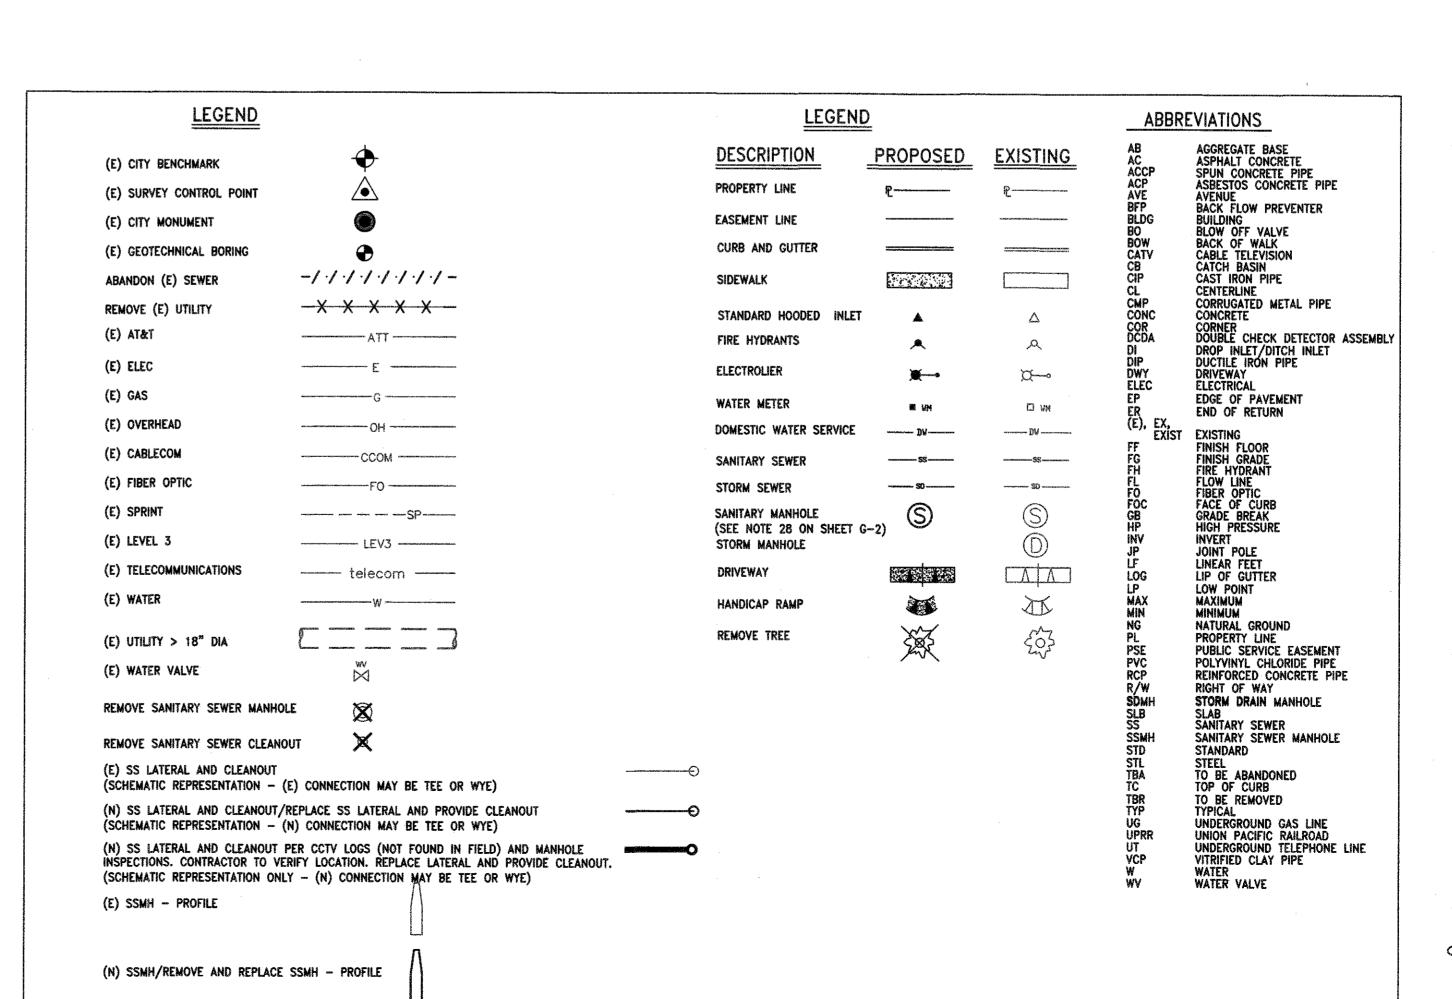



FILE NUMBER: *302T17* RINT DATE: 6/5/2019 SHEET NUMBER:

PROJECT NOTES:

- 1. ALL UTILITIES SHOWN ON THESE PLANS WERE SCALED FROM THE UTILITY MAPS RECEIVED FROM THE UTILITY COMPANIES. THEY ARE NOT NECESSARILY COMPLETE AND ARE BASED ON THE INFORMATION AND PARTIAL TOPOGRAPHIC SURVEY DATA AVAILABLE TO THE DESIGN ENGINEER AT THE TIME THESE PLANS WERE PRODUCED. THE ACTUAL LOCATIONS OF THE UTILITIES SHOWN ON THESE PLANS AND ALL UTILITIES AND CONDITIONS SHOWN MUST BE VERIFIED IN THE FIELD BY THE CONTRACTOR.
- 2. THE CONTRACTOR SHALL CONTACT UNDERGROUND SERVICE ALERT (USA) AT 1-800-227-2600 A MINIMUM OF TWO (2) DAYS PRIOR TO SCHEDULED START OF CONSTRUCTION AND HAVE ALL UTILITY LOCATIONS MARKED IN THE FIELD PRIOR TO THE START OF CONSTRUCTION. CONTRACTOR TO PROVIDE CITY WITH USA CONFIRMATION NUMBER FOR EACH LOCATION.
- 3. THE CONTRACTOR SHALL POTHOLE AND VERIFY THE LOCATION AND DEPTH OF EXISTING UTILITIES TO REMAIN AND SHALL PROTECT SAID UTILITIES DURING CONSTRUCTION.
- 4. FOR OPEN CUT SEWER INSTALLATION OR REPLACEMENT, PROVIDE SHOP DRAWINGS WITH POTHOLED UTILITY INFORMATION DISPLAYED FOR REVIEW BY THE ENGINEER 72 HOURS MINIMUM PRIOR TO COMMENCEMENT OF ANY EXCAVATION OF THESE SEGMENTS.
- 5. PROVIDE TEMPORARY UTILITY SUPPORT USING CONTROLLED LOW STRENGTH MATERIAL TO PROTECT EXISTING UTILITIES AND APPURTENANCES IN PLACE DURING SEWER CONSTRUCTION, SEE SPECIFICATION SECTION 31 23 23.33.
- 6. NO STORAGE OF MATERIALS OR EQUIPMENT SHALL BE PERMITTED ON ROADWAYS AFTER WORK HOURS WITHOUT WRITTEN PERMISSION FROM CITY.
- 7. TRAFFIC CONTROL MEASURES SHALL BE IMPLEMENTED PER APPROVED TRAFFIC CONTROL PLANS AT ALL TIMES DURING THE CONSTRUCTION PERIOD IN COMPLIANCE WITH TECHNICAL SPECIFICATION SECTION 01 55 26. "TRAFFIC CONTROL"
- 8. APPROVED PROTECTIVE MEASURES SHALL BE USED FOR ALL EXCAVATIONS PER SECTION 31 23 00 "EARTHWORK", AND SECTION 31 41 00 "EXCAVATION SUPPORT, SHORING AND BRACING".
- 9. ALL MONUMENTS DISTURBED BY CONSTRUCTION SHALL BE RECORDED PRIOR TO DISTURBANCE. ALL MONUMENTS DISTURBED BY CONSTRUCTION SHALL BE REPLACED BY A PROFESSIONAL LAND SURVEYOR REGISTERED IN THE STATE OF CALIFORNIA. REPLACEMENT WORK SHALL BE COORDINATED AND DOCUMENTED WITH THE CITY ENGINEER.
- 10. RE-STRIPE ALL PAVED AREAS DAMAGED BY CONSTRUCTION WITH THERMOPLASTIC OR AS REQUIRED BY THE CITY IN CONFORMANCE WITH SECTION 32 17 23. "TRAFFIC STRIPES AND PAVEMENT MARKINGS." MARKING TYPES SHALL MATCH EXISTING TYPE.
- 11. COMPLETE CONSTRUCTION PER THE MOST RECENT EDITIONS OF THE CITY OF MORGAN HILL STANDARD SPECIFICATIONS, DESIGN STANDARDS, AND STANDARD DETAILS FOR CONSTRUCTION, EXCEPT AS MODIFIED BY THESE CONTRACT DOCUMENTS.
- 12. THE CONTRACTOR SHALL REMOVE ALL USA PAINT MARKINGS FROM PAVEMENT, SIDEWALKS, AND CONCRETE WITHIN THE PROJECT BOUNDARY FOLLOWING THE COMPLETION OF CONSTRUCTION. COVERING MARKINGS WITH PAINT WILL NOT BE ALLOWED.
- 13. DAMAGE TO STREET LIGHTING, TRAFFIC SIGNAL OR TRAFFIC LOOP FACILITIES DURING CONSTRUCTION SHALL BE REPAIRED IN ACCORDANCE WITH CALTRANS STANDARDS SECTIONS 86 AND 87. TRAFFIC SIGNAL LOOPS DAMAGED BY THE WORK SHALL BE REPLACED WITH TYPE D LOOPS PER CALTRANS STANDARD PLAN ES-5B.
- 14. THE CONTRACTOR SHALL BE REQUIRED TO COORDINATE THEIR CONSTRUCTION SCHEDULE WITH PG&E. A PG&E INSPECTOR SHALL BE ONSITE DURING PRECONSTRUCTION SUBSURFACE UTILITY EXPLORATION POTHOLING AND DURING PIPELINE CONSTRUCTION WITHIN TEN (10) FEET OF GAS TRANSMISSION LINES.
- 15. NEW MANHOLES SHALL BE CONSTRUCTED AS NOTED ON THE PLANS AND PER CITY STANDARD DETAILS.
- 16. IN OPEN CUT SEWER REPLACEMENT SECTIONS, CONTRACTOR SHALL REMOVE AND DISPOSE OF EXISTING SEWER PIPE.
- 17. NEW SEWER PIPE SHALL BE THE MATERIAL AS NOTED ON THE DRAWINGS.
- 18. REPLACEMENT AND REPAIR OF CITY OWNED FACILITIES NOT SPECIFICALLY DETAILED IN THE PLANS SHALL BE IN ACCORDANCE WITH APPLICABLE CITY STANDARD SPECIFICATIONS AND DETAILS.
- 19. CONTRACTOR SHALL FIELD LOCATE AND VERIFY ALL EXISTING LATERALS. SEWER LATERAL RECONNECTION SHALL BE IN ACCORDANCE WITH THE CITY STANDARD DETAILS. WHERE ADJACENT UTILITIES PREVENT LATERAL RECONNECTION TO NEW 27-INCH MAIN AT A 45 DEGREE ANGLE PER CITY STANDARD DETAIL S-2. LATERALS SHALL BE CONNECTED TO THE NEW MAIN PER DETAIL 2 ON SHEET D-2. LATERALS TO BE EXTENDED FROM THE ABANDONED 18-INCH MAIN TO THE NEW 27-INCH MAIN SHALL BE EXTENDED PER DETAIL 2 ON SHEET D-2. SEWER LATERAL CONNECTIONS SHALL BE PLACED PRIOR TO SURFACING OF STREETS AND OTHER SURFACE RESTORATIONS.
- 20. RIGHT OF WAY AND PROPERTY LINES WHERE SHOWN ARE BASED UPON RECORD DATA AND ARE SHOWN FOR INFORMATIONAL PURPOSES ONLY.
- 21. EXISTING SANITARY SEWER MANHOLES WHICH ARE NOT TO BE REPLACED, REMOVED, OR ABANDONED SHALL BE PROTECTED IN PLACE.
- 22. CONTRACTOR TO REPLACE SOD, LANDSCAPING, AND IRRIGATION DAMAGED DUE TO HIS OPERATIONS TO CONDITION ACCEPTABLE TO ENGINEER AT NO ADDITIONAL COST TO
- 23. NO REVISIONS SHALL BE MADE TO THESE PLANS WITHOUT THE APPROVAL OF THE CITY.
- 24. FOR SEWER BYPASS REQUIREMENTS, SEE SPECIFICATION SECTION 33 01 30.01.

DATE BY

25. NO DISRUPTION TO EXISTING SEWER SERVICES SHALL BE ALLOWED DURING CONNECTION TO THE EXISTING MAINS WITHOUT THE EXPRESSED APPROVAL OF THE CITY.

AH

TYPINGR SCOTT CREER RCE 58879 EXP. 06/30/19

NTS

NTS

LV

APPROVED:

RF, TKS

- 26. CONTRACTOR TO BROOM SWEEP CONSTRUCTION AREA EACH NIGHT PRIOR TO LEAVING THE JOB SITE.
- 27. CONTROL FOR MANHOLE STATIONING IS CENTER OF MANHOLE STRUCTURE, NOT CENTER OF MANHOLE FRAME AND COVER.

AS-BUILT CORRECTIONS

Revisions

28. FOR MANHOLE LOCATIONS SEE SHEET G-4.


DESCRIPTION

City of Morgan Hill Public Works Department JOB NUMBER: CITY OF MORGAN HILL 376483 100 Edes Ct. Morgan Hill, CA 95037 (408)776-7337, Fax (408)779-6282



2077 GATEWAY PLACE SUITE 550 SAN JOSE, CA 95110 WWW.MOTTMAC.COM

PROJECT NOTES TENNANT AVENUE **SEWER MAIN PROJECT**

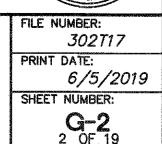

KEY MAP

N.T.S

NOTES:

1. GEOTECHNICAL BORING LOCATIONS SHOWN ARE APPROXIMATE. DEPTH OF BORINGS IS 20FT. A GEOTECHNICAL REPORT IS AVAILABLE UPON REQUEST FOR REFERENCE ONLY.

APPROXIMATE GEOTECHNICAL BORING LOCATION.

VERT:

NTS

VERT:

NTS

JOB NUMBER:

376483 AS-BUILT CORRECTIONS DATE: 6/6/19 DATE BY DESCRIPTION DATE: Revisions TYENGR SCOTT CREER RCE 58879 EXP. 06/30/19




City of Morgan Hill Public Works Department 100 Edes Ct. Morgan Hill, CA 95037 (408)776-7337, Fax (408)779-6282

2077 GATEWAY PLACE SUITE 550 SAN JOSE, CA 95110 WWW.MOTTMAC.COM MOTT NACONALD

KEY MAP TENNANT AVENUE SEWER MAIN PROJECT FILE NUMBER:
302T17 PRINT DATE: 6/5/2019 SHEET NUMBER: **G-3** 3 OF 19



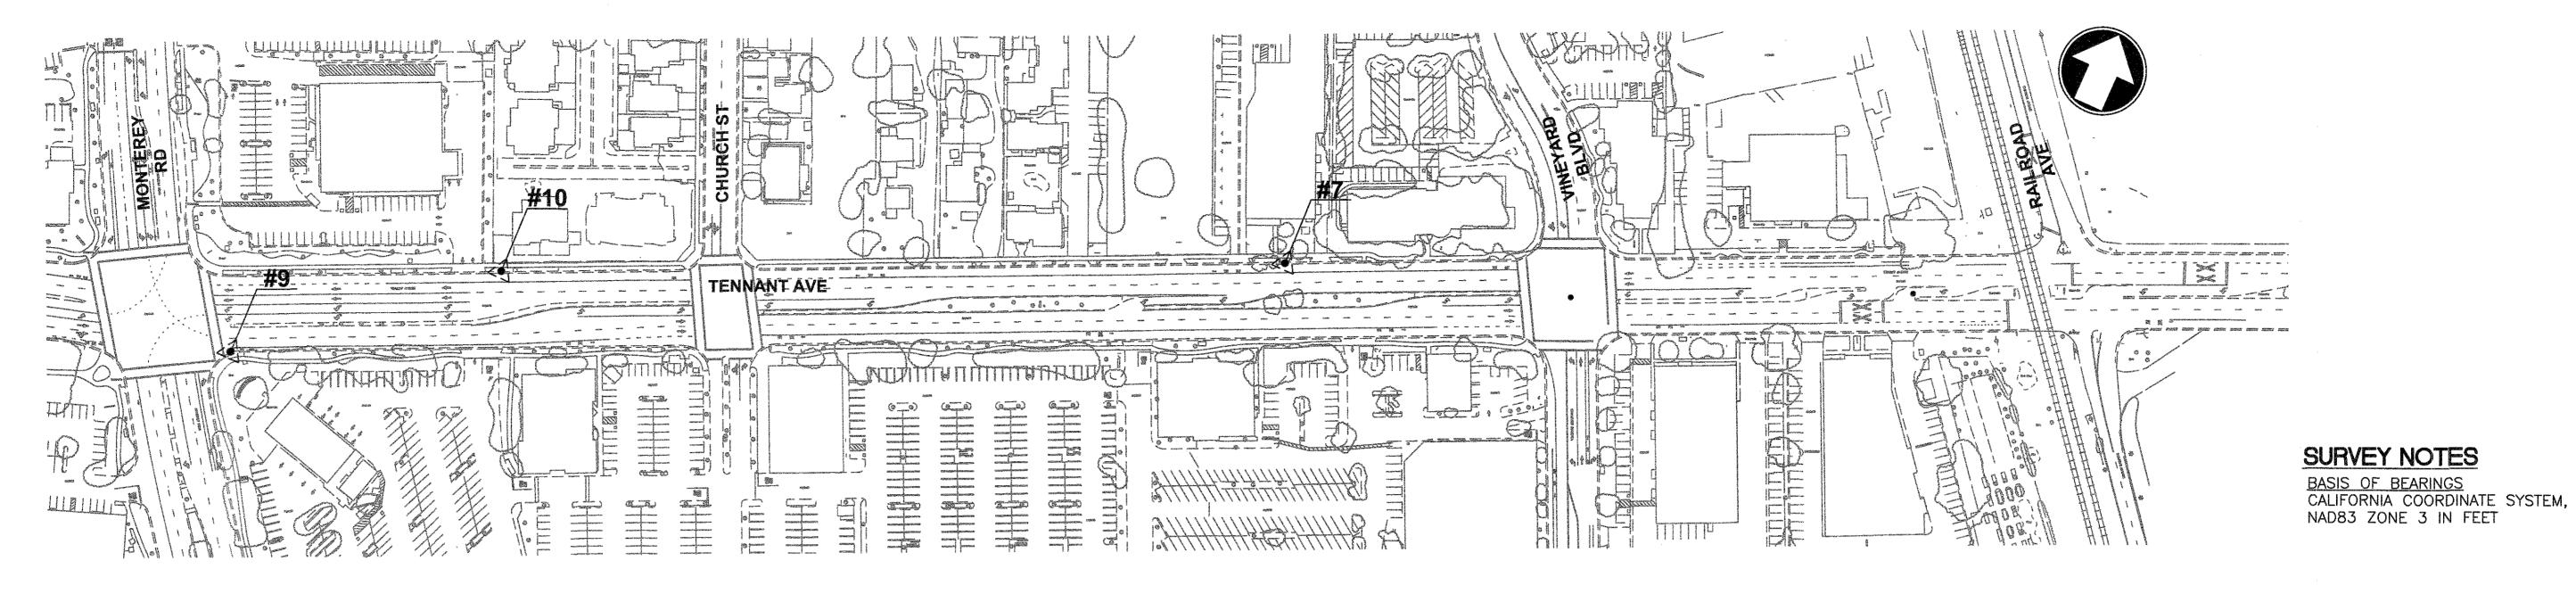

VERTICAL CONTROL BENCHMARK TABLE

SCVWD BM #	ELEV (FT) NAVD88	CITY BENCHMARK DESCRIPTION	
BM321	330.37	BRASS DISK, TOP OF SW, 3' EAST OF WESTERLY CONCRETE HEADWALL, NW CORNER OF EDMUNDSON AVE/WEST LITTLE LLAGAS CREEK, 300' W FROM MONTEREY RD ALONG N SIDE OF EDMUNDSON AVE	

SURVEY CONTROL POINT TABLE

PT#	NORTHING	EASTING	DESCRIPTION
7	1866231.964	6229592.981	MAGNETIC NAIL AND RIBBON
9	1865635.823	6228510.516	MAGNETIC NAIL AND RIBBON
10	1865850.496	6228760.909	MAGNETIC NAIL AND RIBBON

SURVEY CONTROL

MANHOLE LOCATION TABLE

MH STATION	NORTHING	EASTING			
200+60	1865680.71	6228474.31			
203+43	1865799.40	6228731.18			
203+99	1865822.79	6228781.53			
206+58	1865931.95	6229016.67			
211+12	1866121.96	6229429.19			
216+19	1866333.81	6229889.51			
220+09	1866496.93	6230243.95			
221+11	1866532.73	6230339.60			
222+50 (300+67)	1866623.04	6230444.89			
222+88	1866649.59	6230417.78			
223+47	1866665.62	6230362.43			
300+00	1866587.58	6230502.09			

NOTE: SEE SHEET G-2, NOTE 28.

WORK ACCEPTED: INSPECTOR:

DRAWN:

AH

NTS

CHECKED:

VERT:

NTS

APPROVED:

DATE:

Revisions

WORK ACCEPTED: INSPECTOR:

DRAWN:

AH


NTS

VERT:

NTS


APPROVED:

CITYENGR SCOTT CREER RCE 58879 EXP. 06/30/19

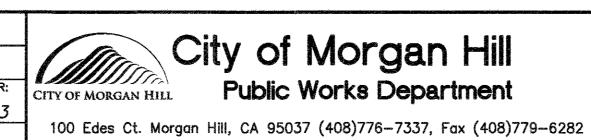






2077 GATEWAY PLACE SUITE 550 SAN JOSE, CA 95110 WWW.MOTTMAC.COM SURVEY CONTROL TENNANT AVENUE SEWER MAIN PROJECT

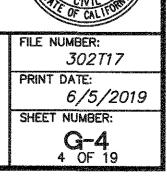


Plotted: Jun 04 , 2019 , 11:23am by VIL85908 File: C:\pwworking\hmm\water_wastewater\luc85908\d0338886\G-4.dwg SYSV: VISRETAIN=1, PSLTSCALE=1, LTSCALE=

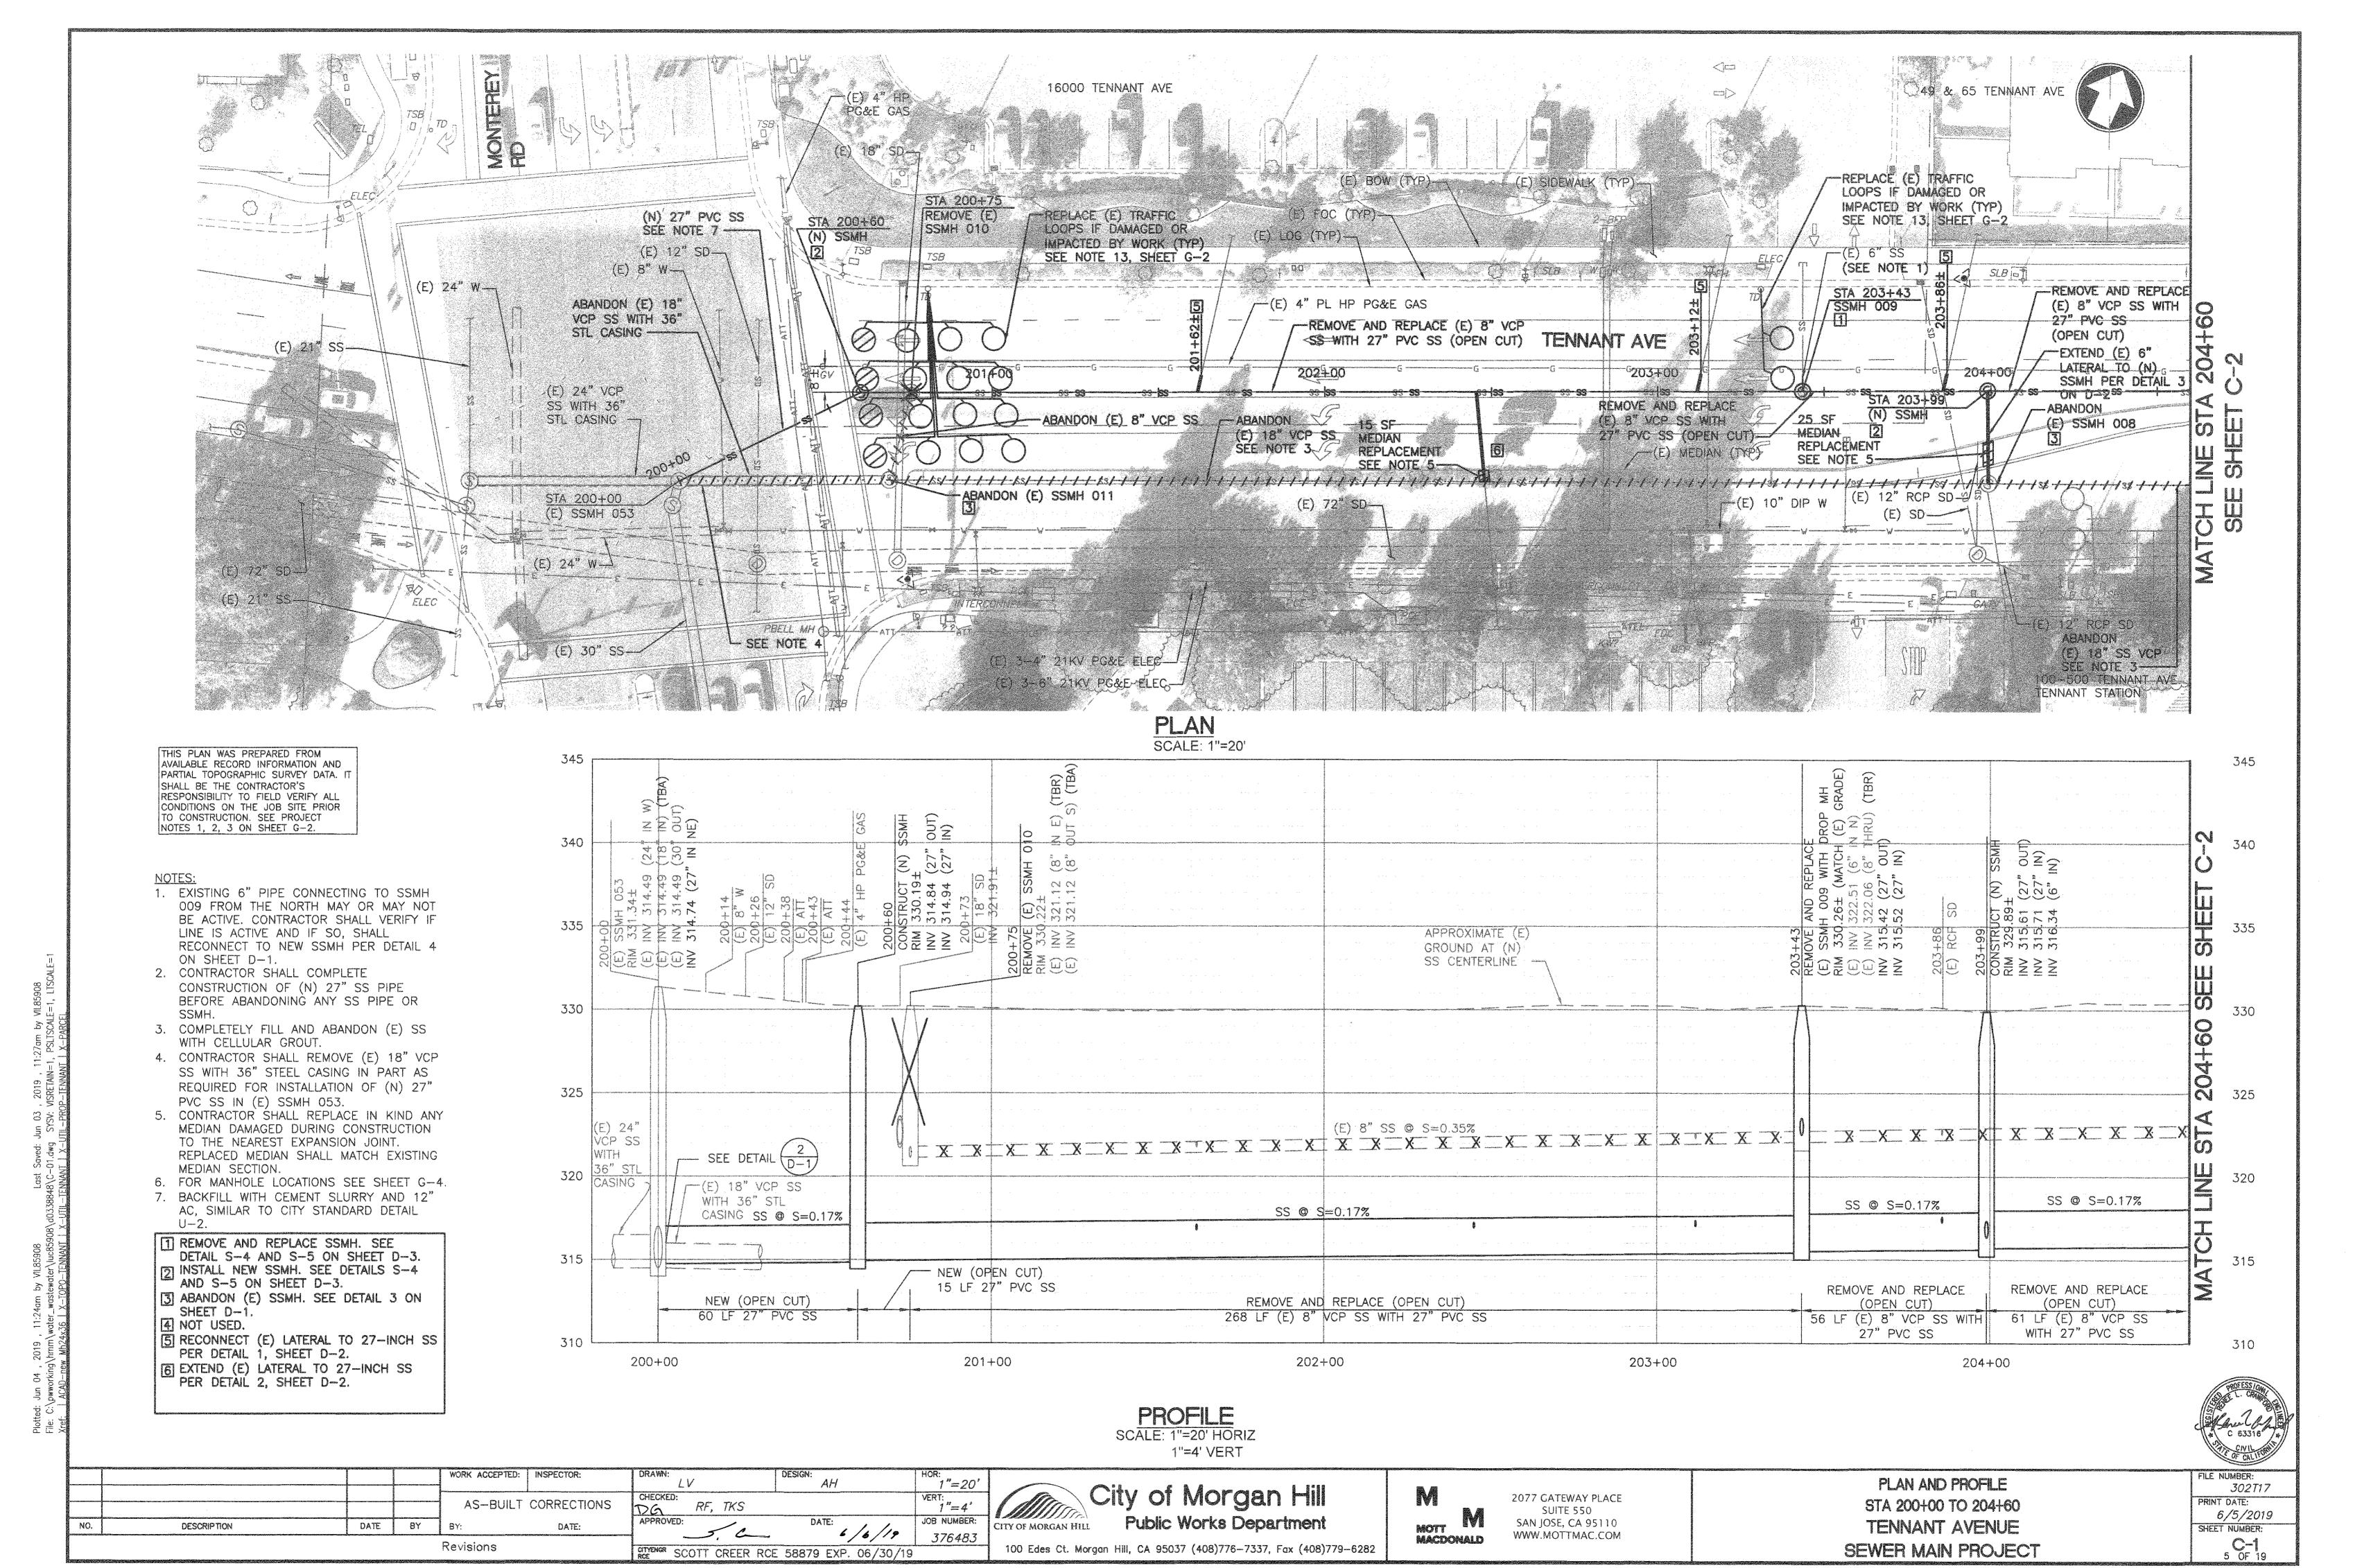

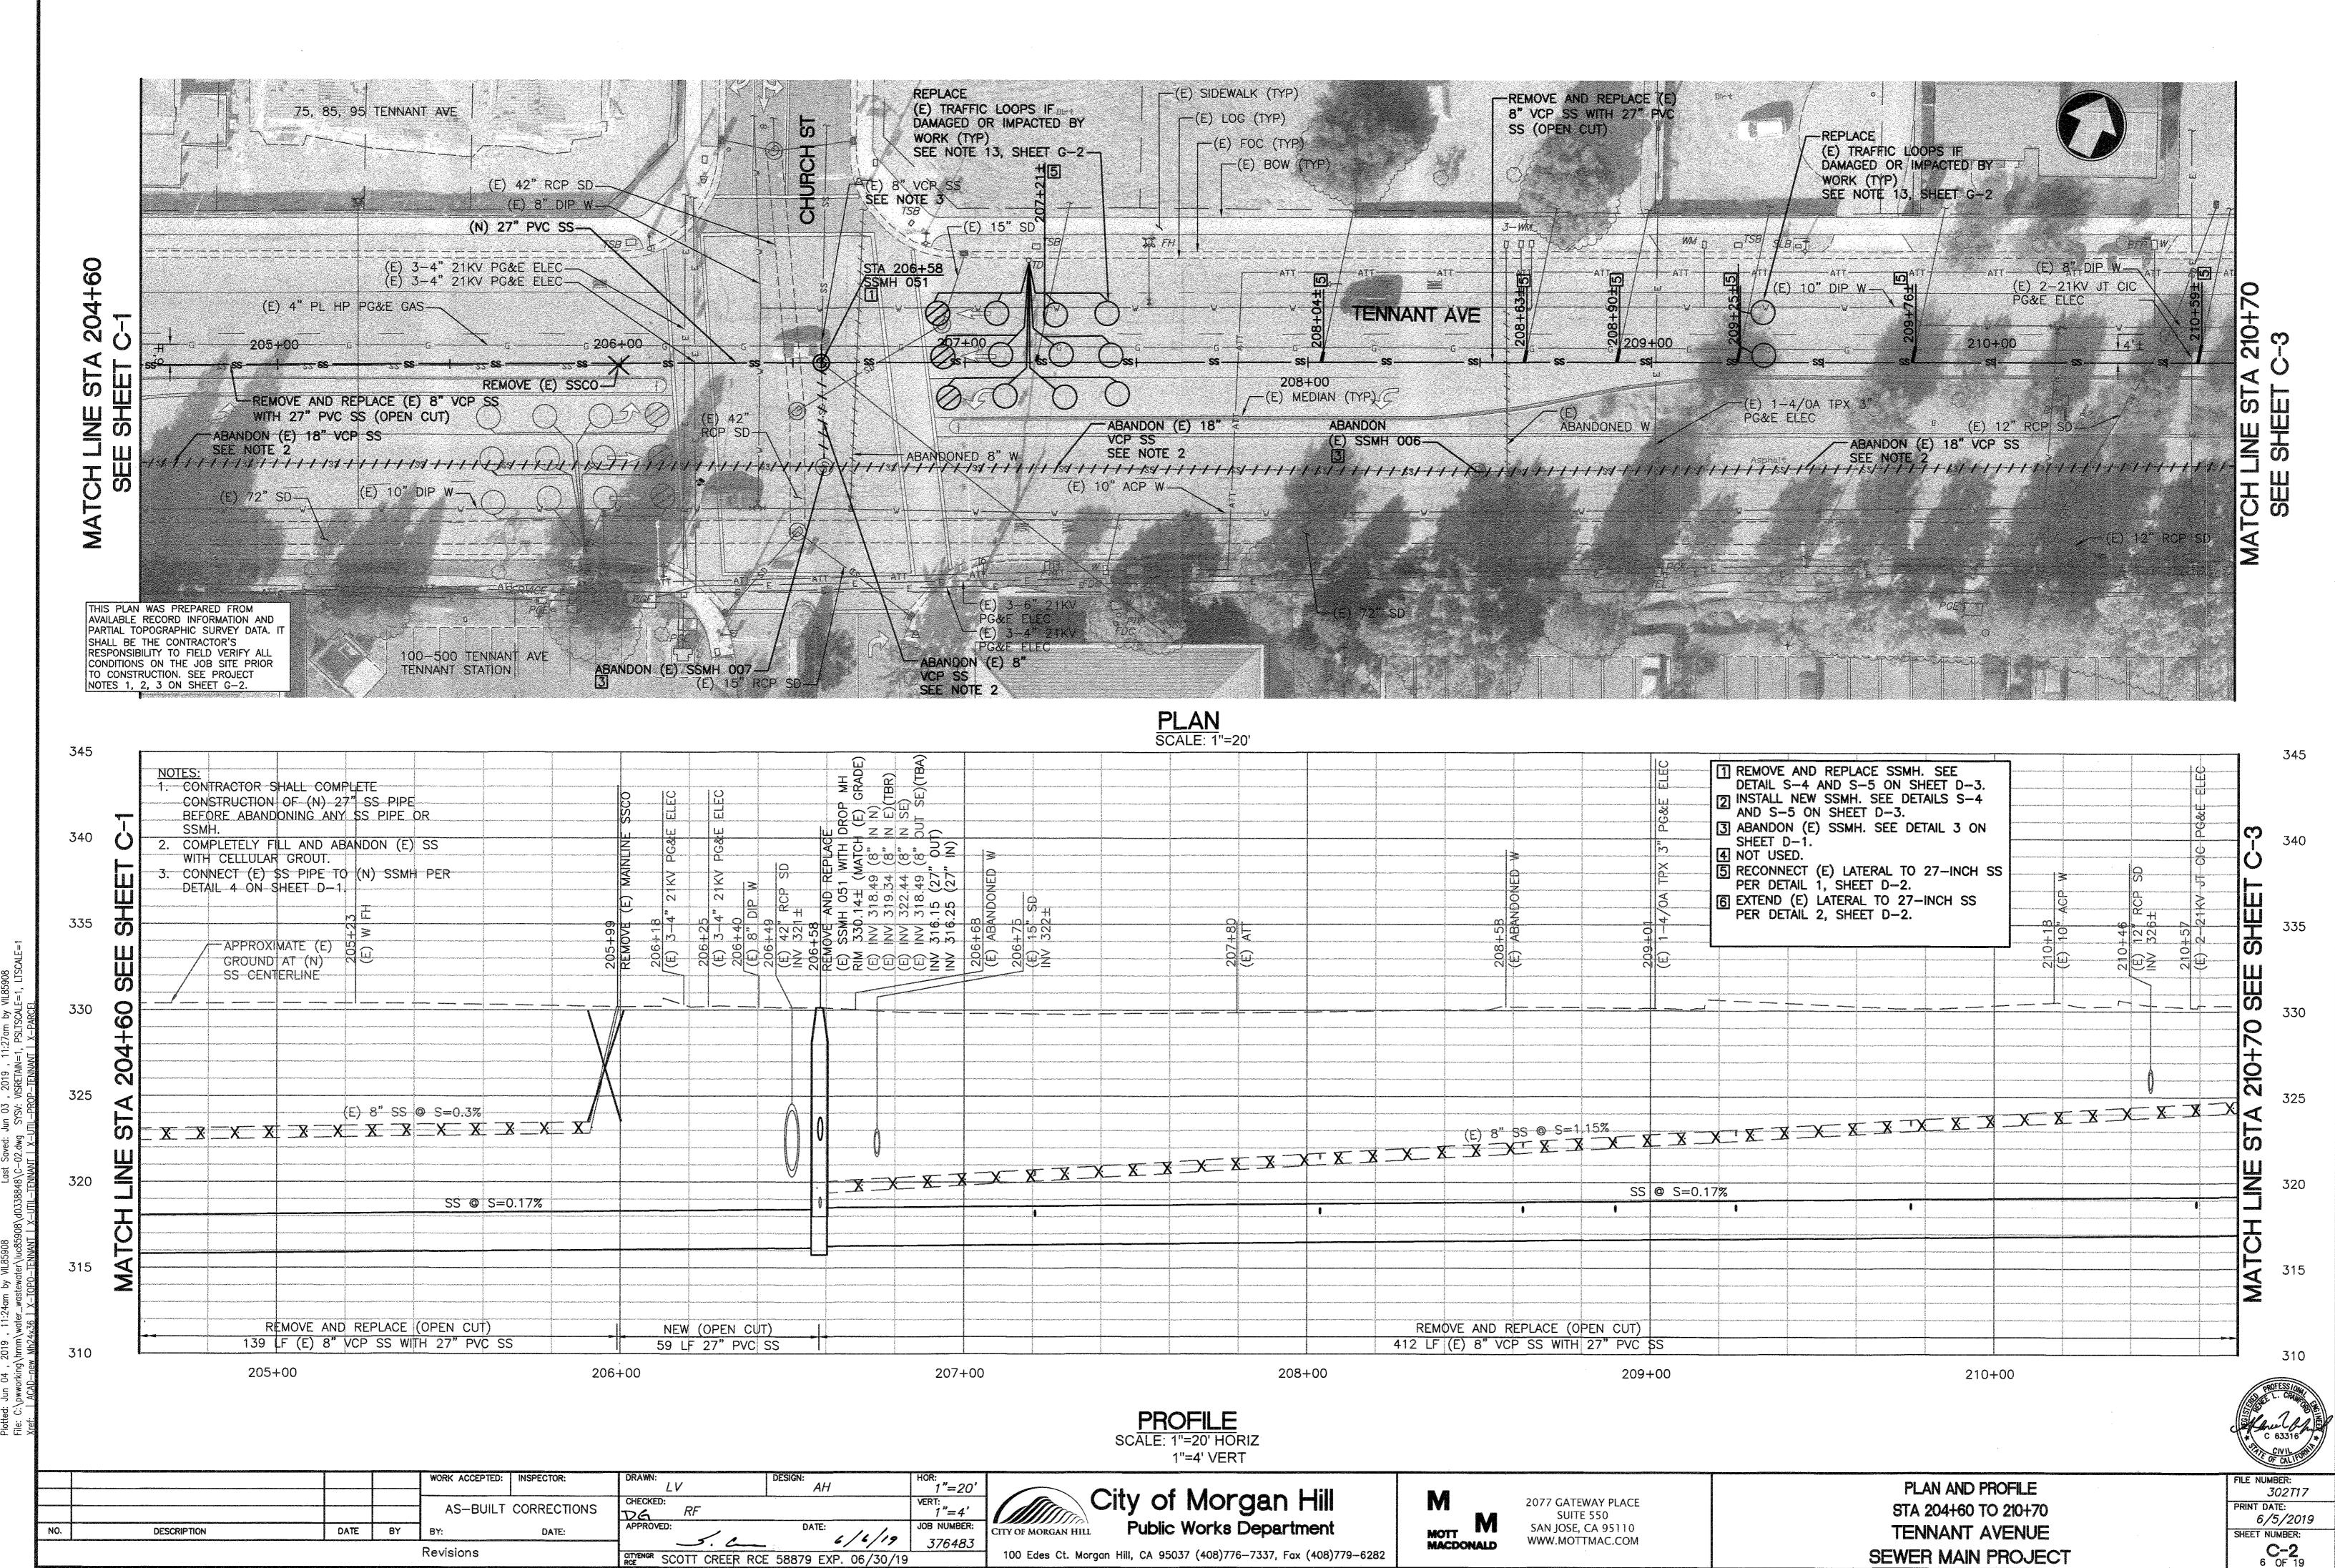

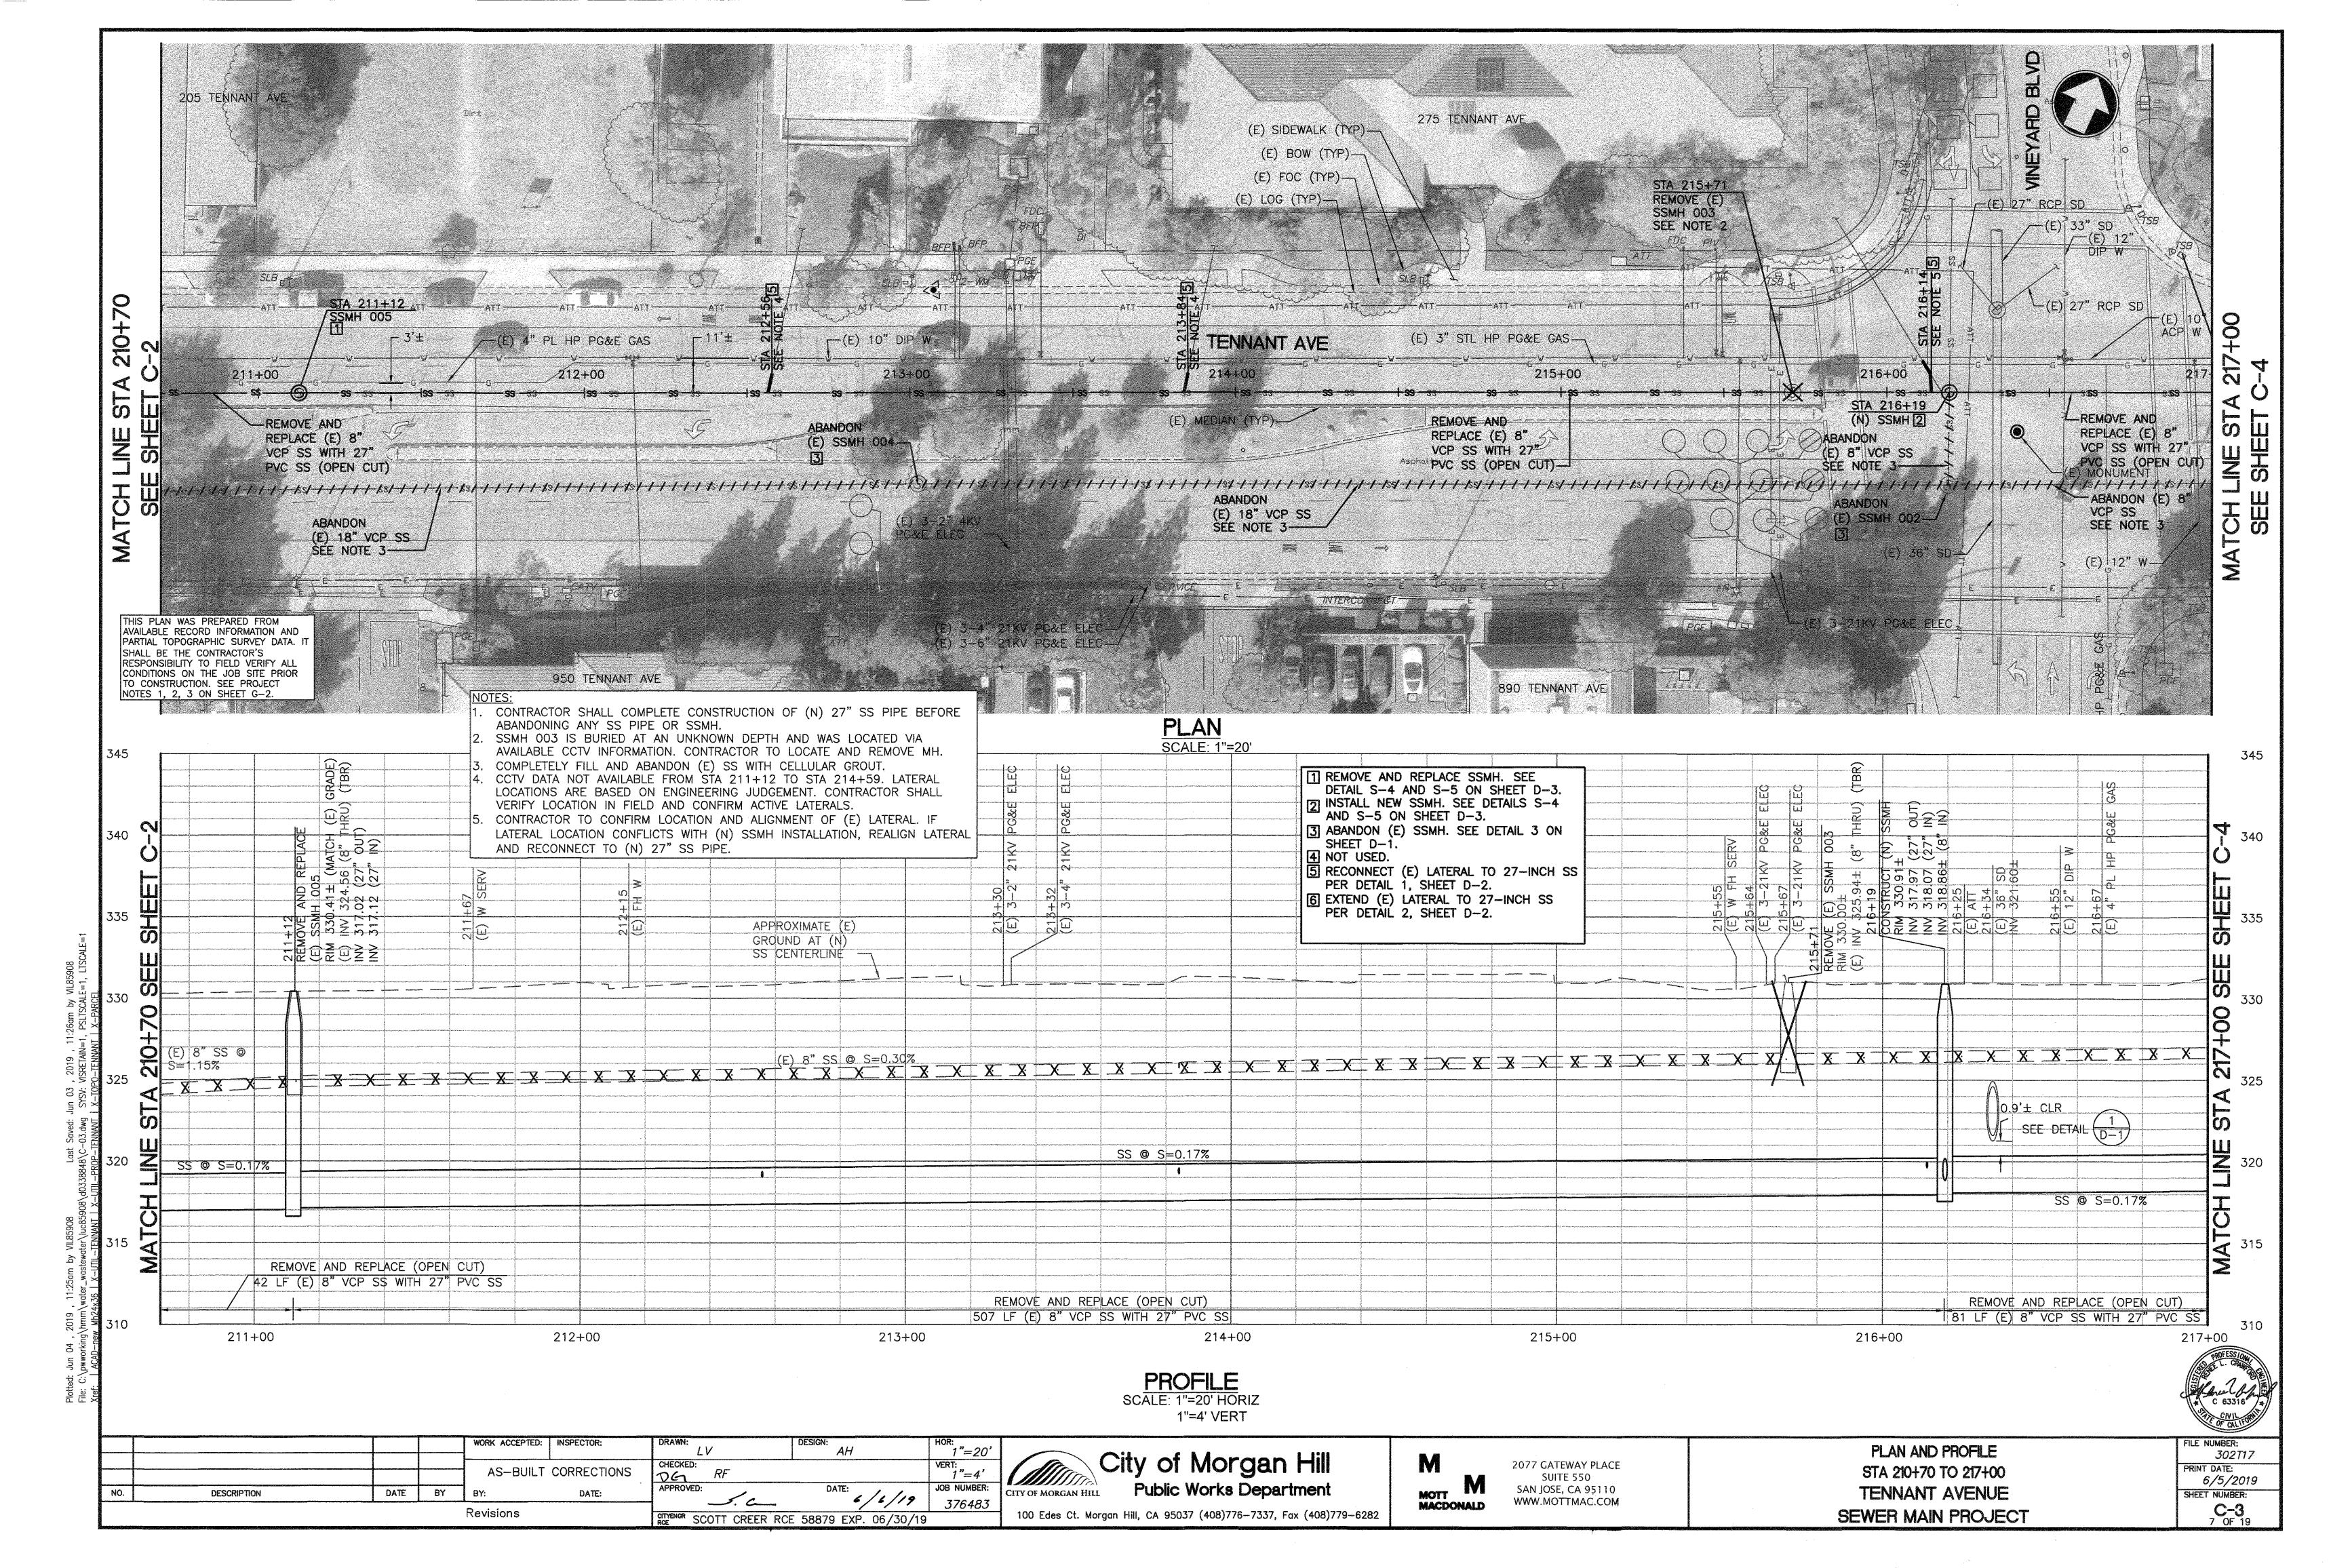

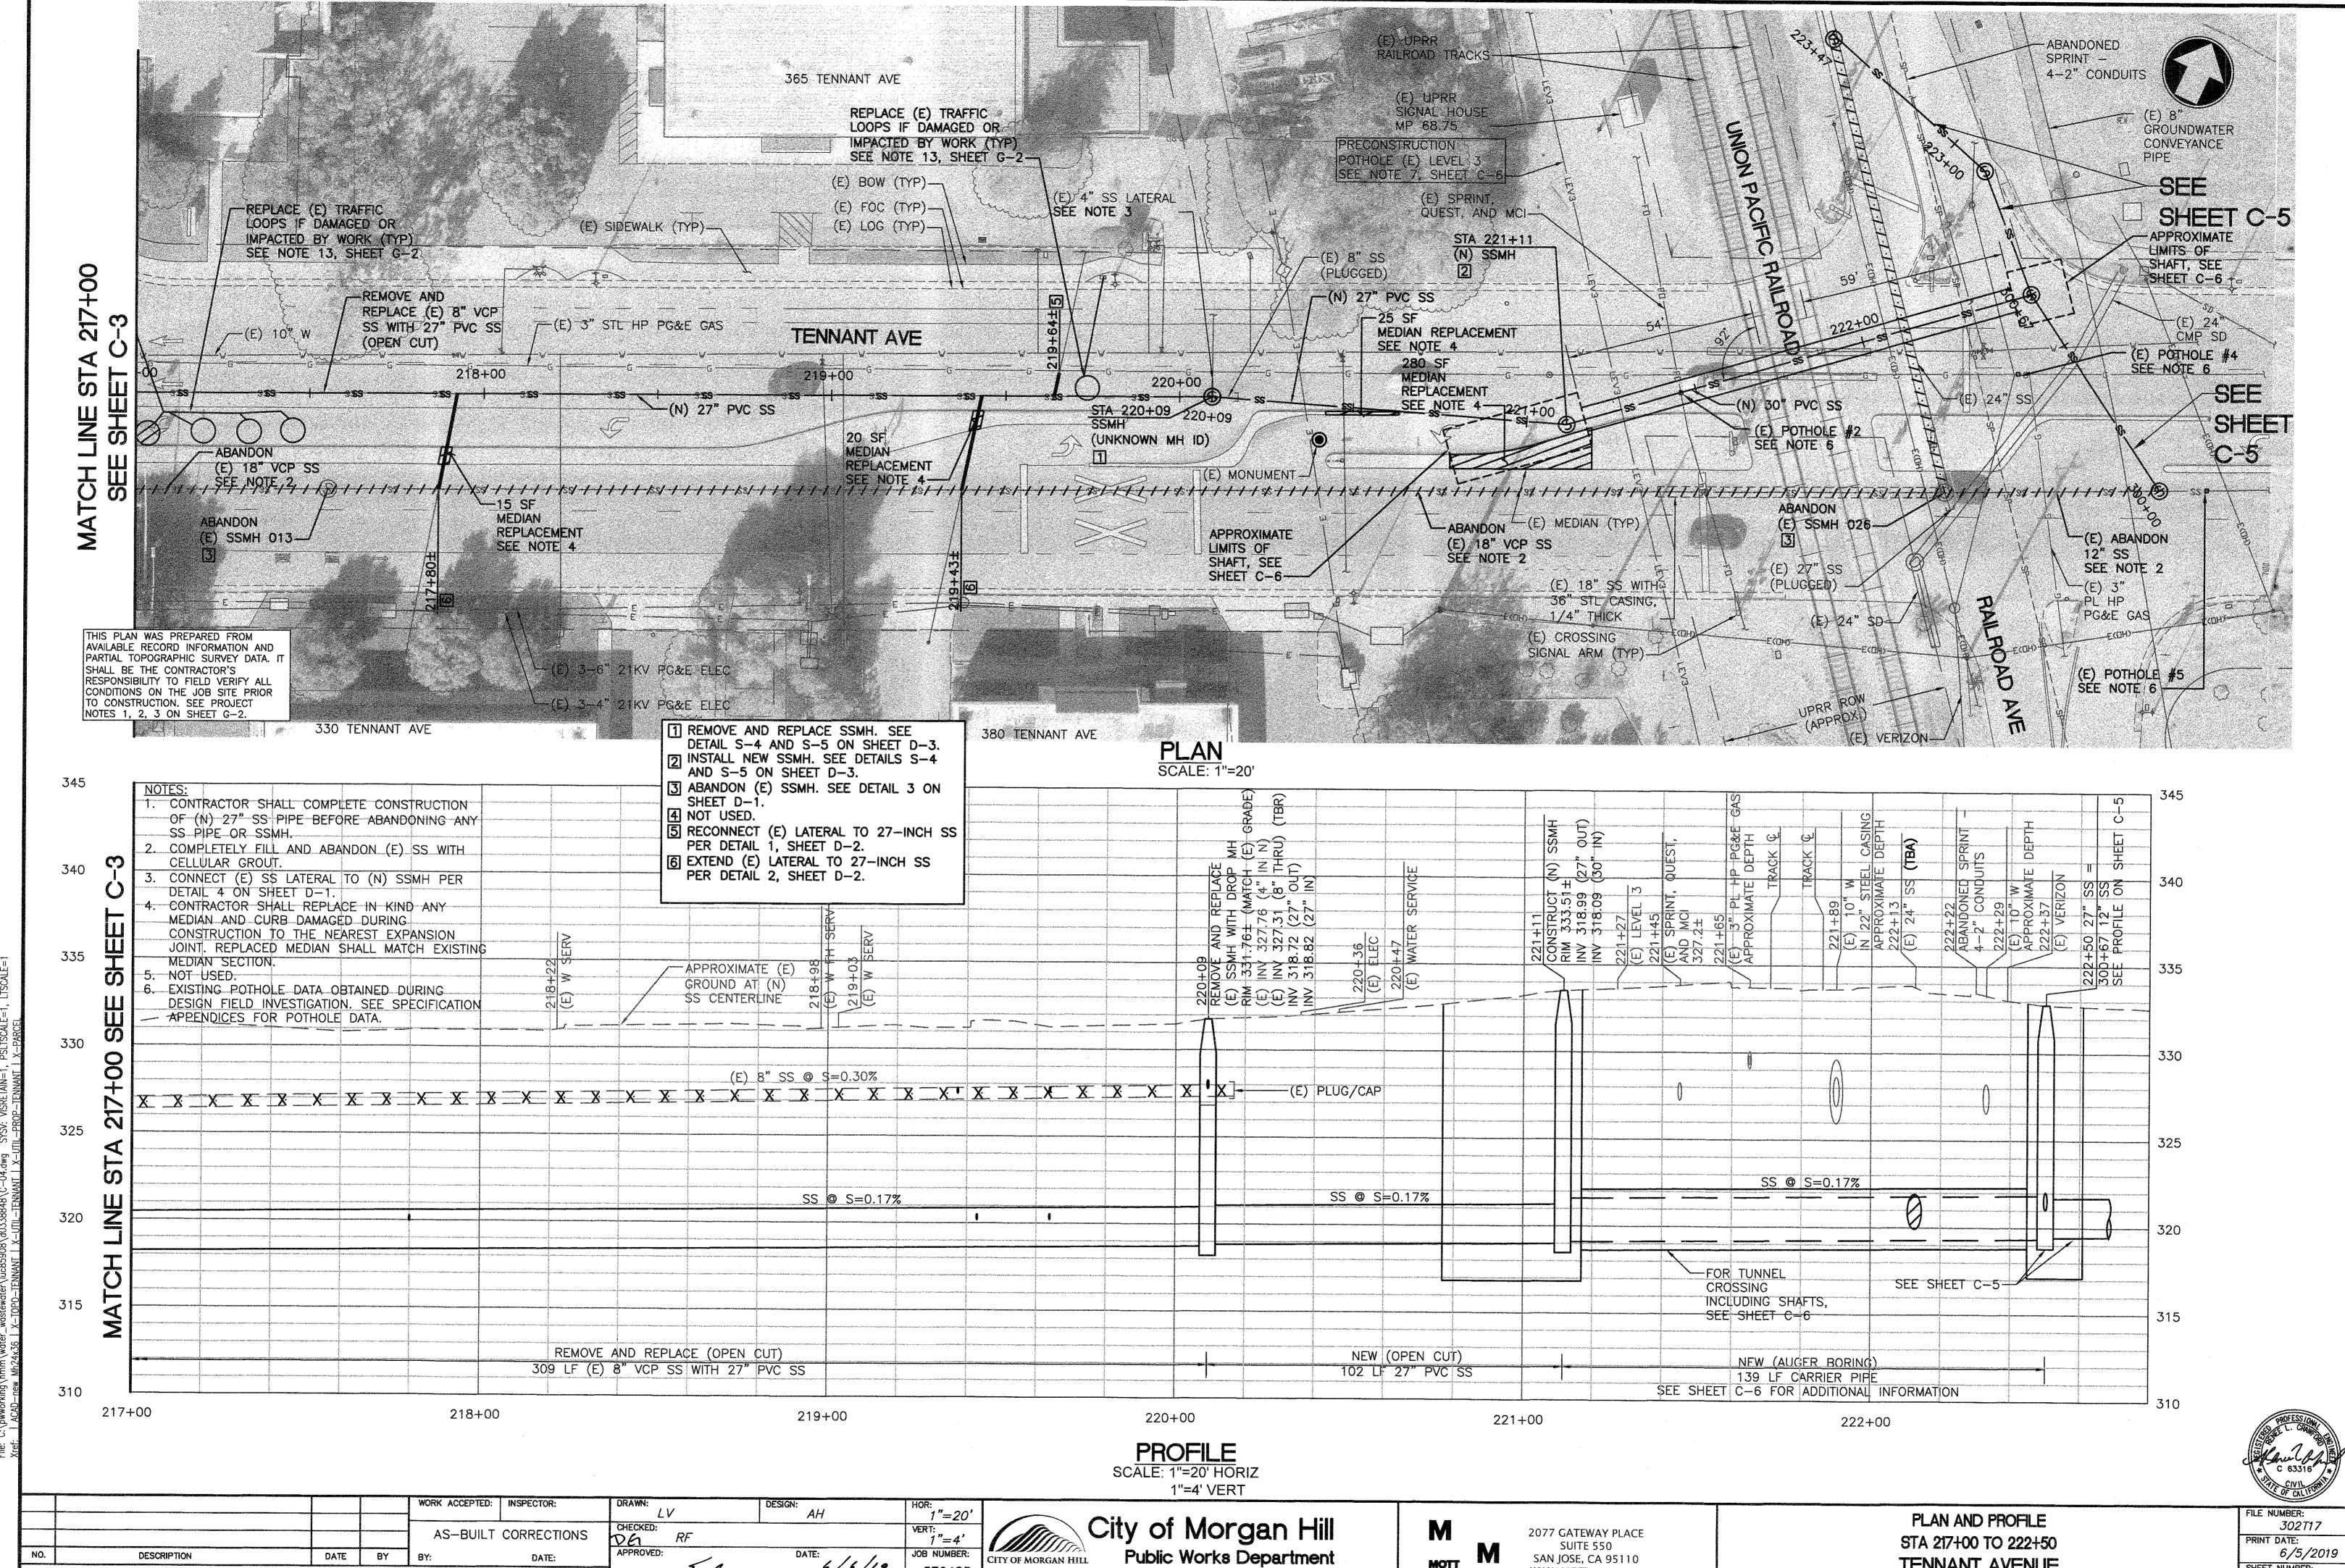


376483 Revisions CITYENGR SCOTT CREER RCE 58879 EXP. 06/30/19

100 Edes Ct. Morgan Hill, CA 95037 (408)776-7337, Fax (408)779-6282



WWW.MOTTMAC.COM

TENNANT AVENUE **SEWER MAIN PROJECT** SHEET NUMBER: **C-4** 8 OF 19

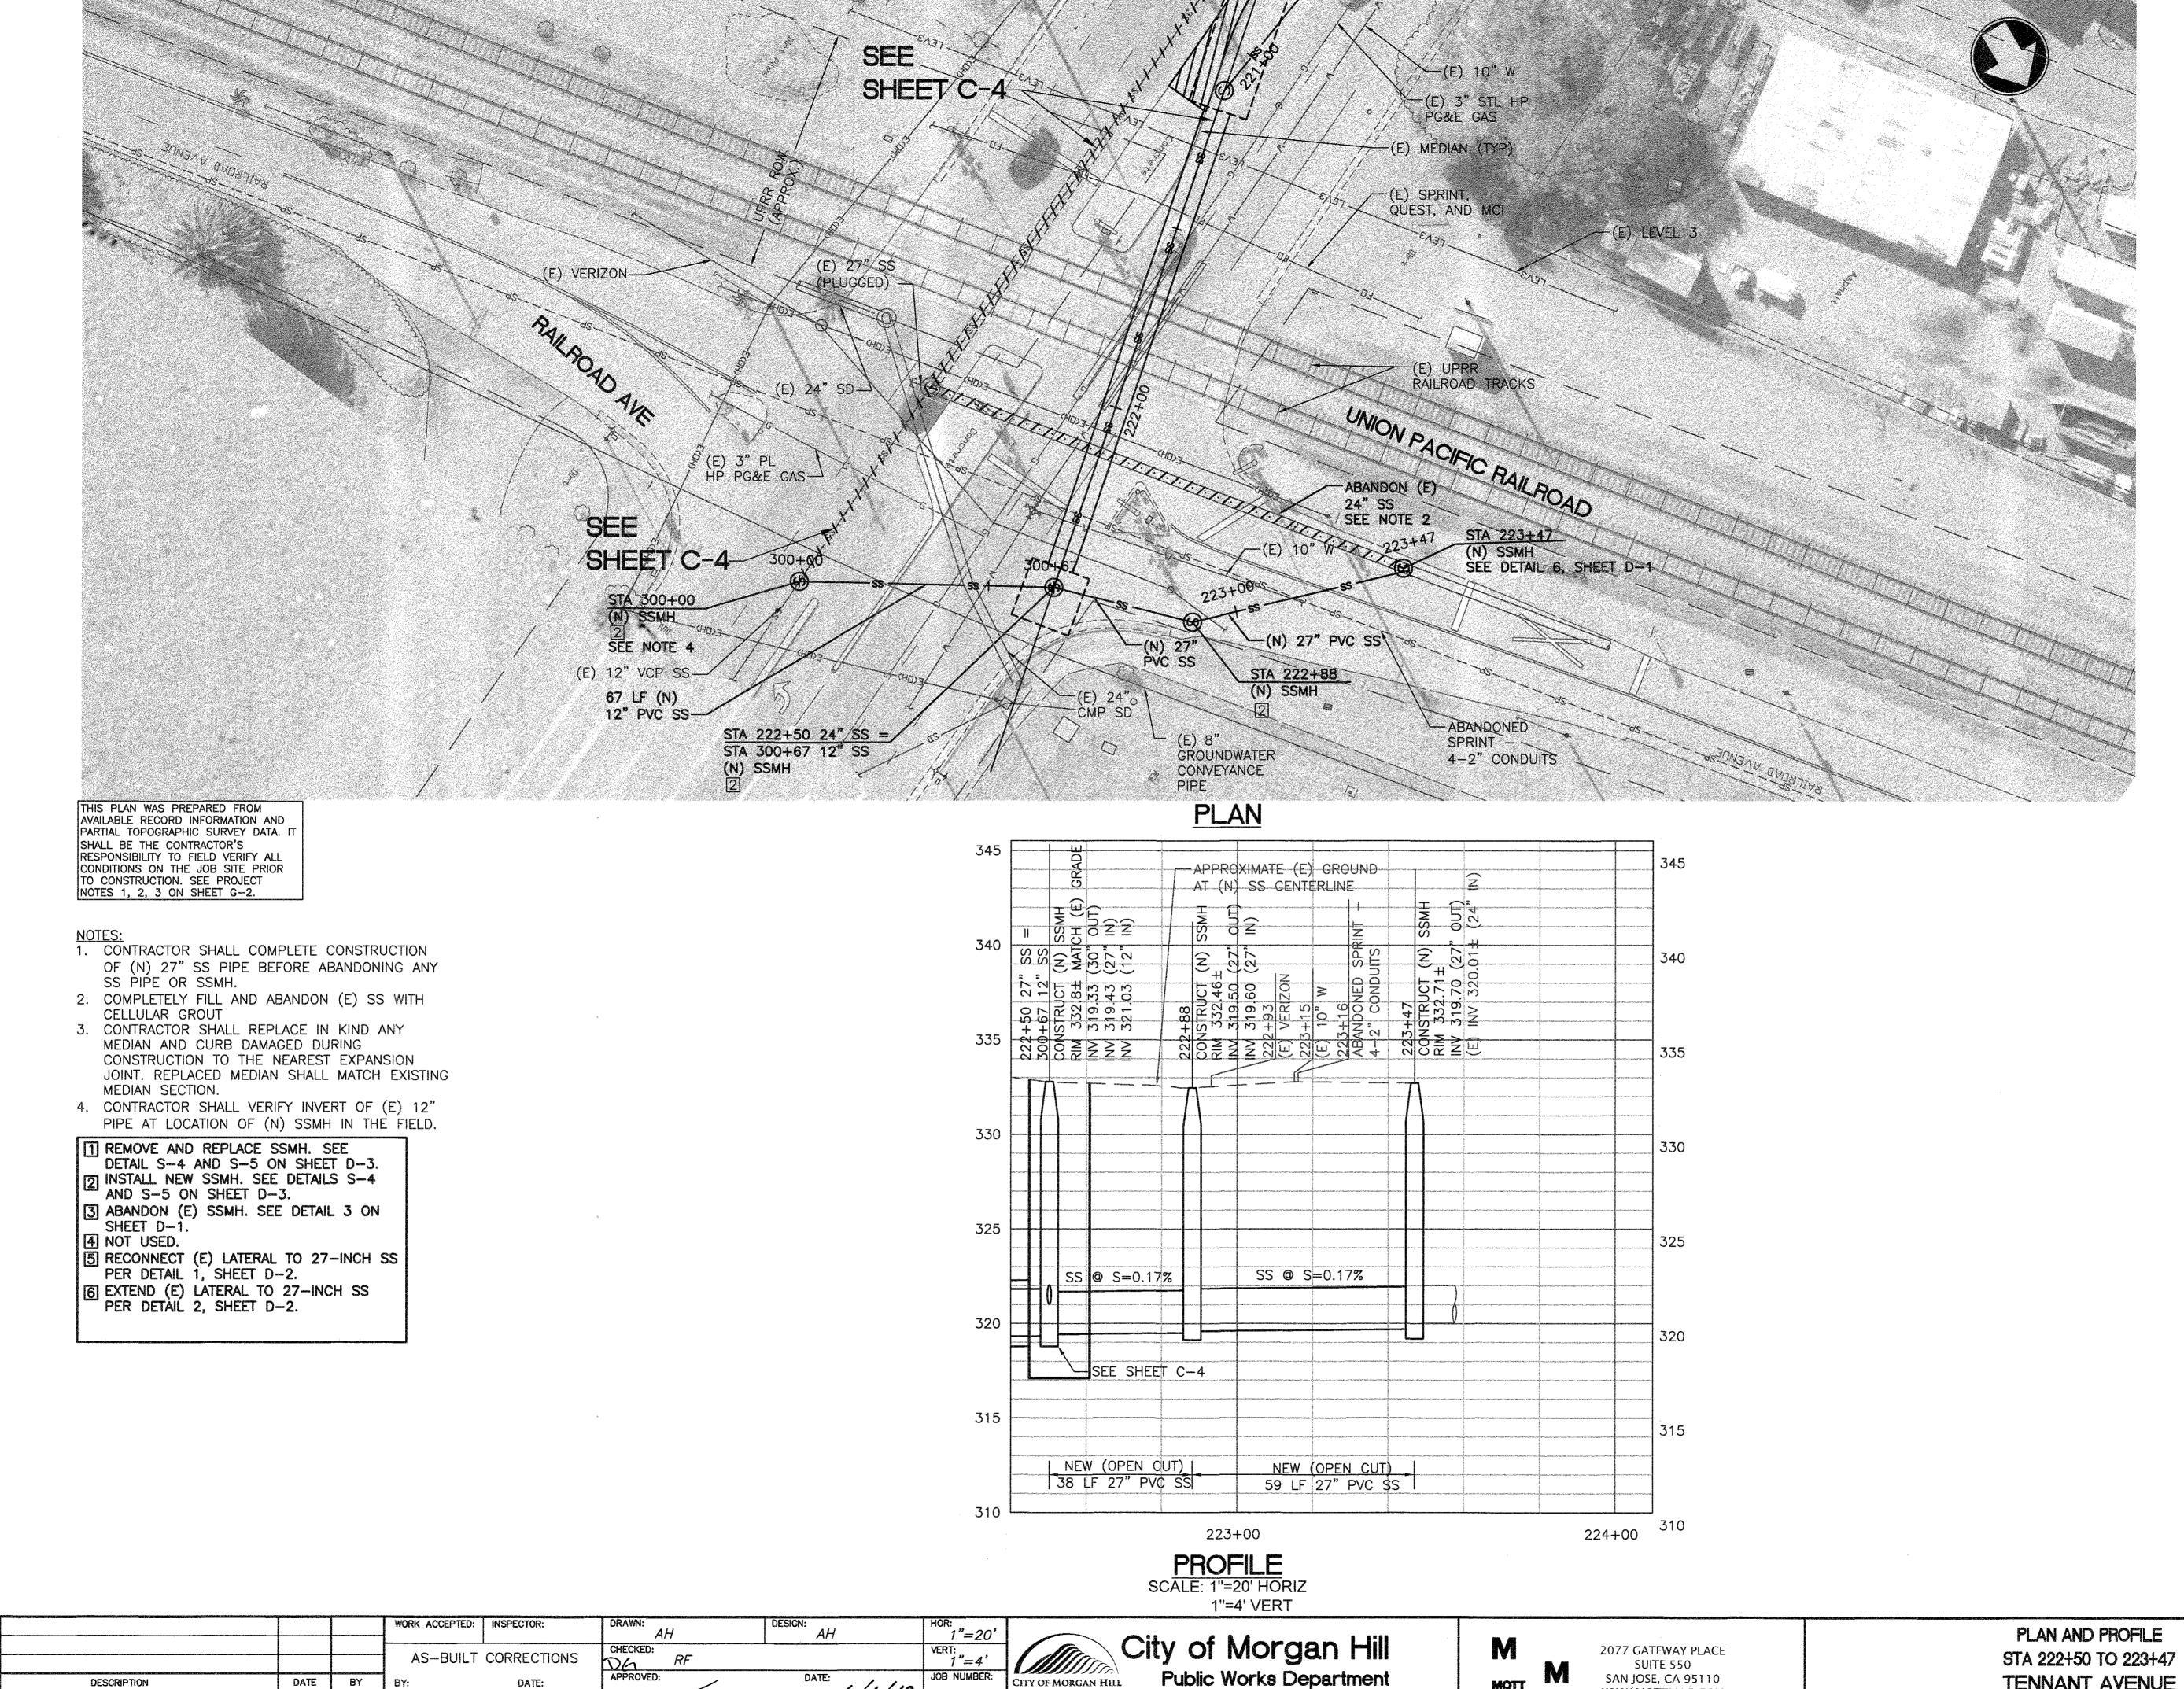

CITY OF MORGAN HILL

100 Edes Ct. Morgan Hill, CA 95037 (408)776-7337, Fax (408)779-6282

6/6/19

CITYENGR SCOTT CREER RCE 58879 EXP. 06/30/19

376483

NO.

DESCRIPTION

DATE BY

BY:

Revisions

DATE:

SAN JOSE, CA 95110

WWW.MOTTMAC.COM

MOTT


MACDONALD


TENNANT AVENUE **SEWER MAIN PROJECT**

302T17 PRINT DATE: 6/5/2019 SHEET NUMBER: **C-5** 9 OF 19

THIS PLAN WAS PREPARED FROM AVAILABLE RECORD INFORMATION AND PARTIAL TOPOGRAPHIC SURVEY DATA. IT SHALL BE THE CONTRACTOR'S RESPONSIBILITY TO FIELD VERIFY ALL CONDITIONS ON THE JOB SITE PRIOR TO CONSTRUCTION. SEE PROJECT NOTES 1, 2, 3 ON SHEET G-2.

- 1. THE CASING LENGTH SHALL EXTEND 12 INCHES MINIMUM INSIDE THE JACKING AND RECEIVING SHAFTS. 2. THE CASING DIAMETER AND WALL THICKNESS SHALL BE
- SELECTED AND VERIFIED BY THE CONTRACTOR AS PER SECTION 33 05 07.24.
- 3. JACKING AND RECEIVING SHAFTS ARE SHOWN ON THESE DRAWINGS AT A TYPICAL DIMENSION AND ONLY FOR PROJECT UNDERSTANDING. THE CONTRACTOR IS RESPONSIBLE FOR SHAFT SHAPE AND SIZE TO SUIT HIS MEANS AND METHODS INCLUDING INTENDED CASING PIPE SEGMENT LENGTH AND SITE CONSTRAINTS INCLUDING EXISTING UTILITIES AND TRAFFIC FLOW REQUIREMENTS. DRAWINGS DO NOT IMPLY THE AREA IS FREE OF CONFLICTING IMPROVEMENTS AND CONTRACTOR TO VERIFY THE LOCATION OF ALL EXISTING UTILITIES PRIOR TO START OF CONSTRUCTION.
- 4. THE CARRIER PIPE SHALL BE INSTALLED AND BACKFILL GROUTED WITHIN THE STEEL CASING IN ACCORDANCE WITH SECTION 33 05 07.23.
- 5. PRIOR TO INSTALLATION OF CASING, ABANDON EXISTING 24" SANITARY SEWER (ASSUMED VCP) AND BACKFILL WITH CELLULAR GROUT. SEE SHEET C-04 FOR ADDITIONAL INFORMATION. SEE SHEET C-7 REGARDING BYPASSING SEWER FLOWS.
- 6. SEE SHEET G-3 FOR INFORMATION ON
- GEOTECHNICAL BORINGS. CONTRACTOR SHALL PERFORM PRECONSTRUCTION POTHOLE OF LEVEL 3 CONDUIT AND PROVIDE TOP ELEVATION OF CONDUIT AND SIZE OF CONDUIT TO ENGINEER FOR VERIFICATION. DATA SHALL BE PROVIDED TO ENGINEER A MINIMUM OF 6 WEEKS PRIOR TO ANY WORK ASSOCIATED WITH AUGER BORING, INCLUDING SHAFT EXCAVATION. CONTRACTOR SHALL BE RESPONSIBLE FOR OBTAINING AND EXECUTING PERMITS AND INSURANCE AGREEMENTS REQUIRED BY UPRR FOR
- 8. AUGER BORING IS FACE OF SHAFT TO FACE OF SHAFT DISTANCE. CARRIER PIPE LENGTH IS MANHOLE TO MANHOLE. STEEL CASING LENGTH IS EQUAL TO THE SUM OF THE AUGER BORING LENGTH AND THE LENGTHS IDENTIFIED IN NOTE 1.

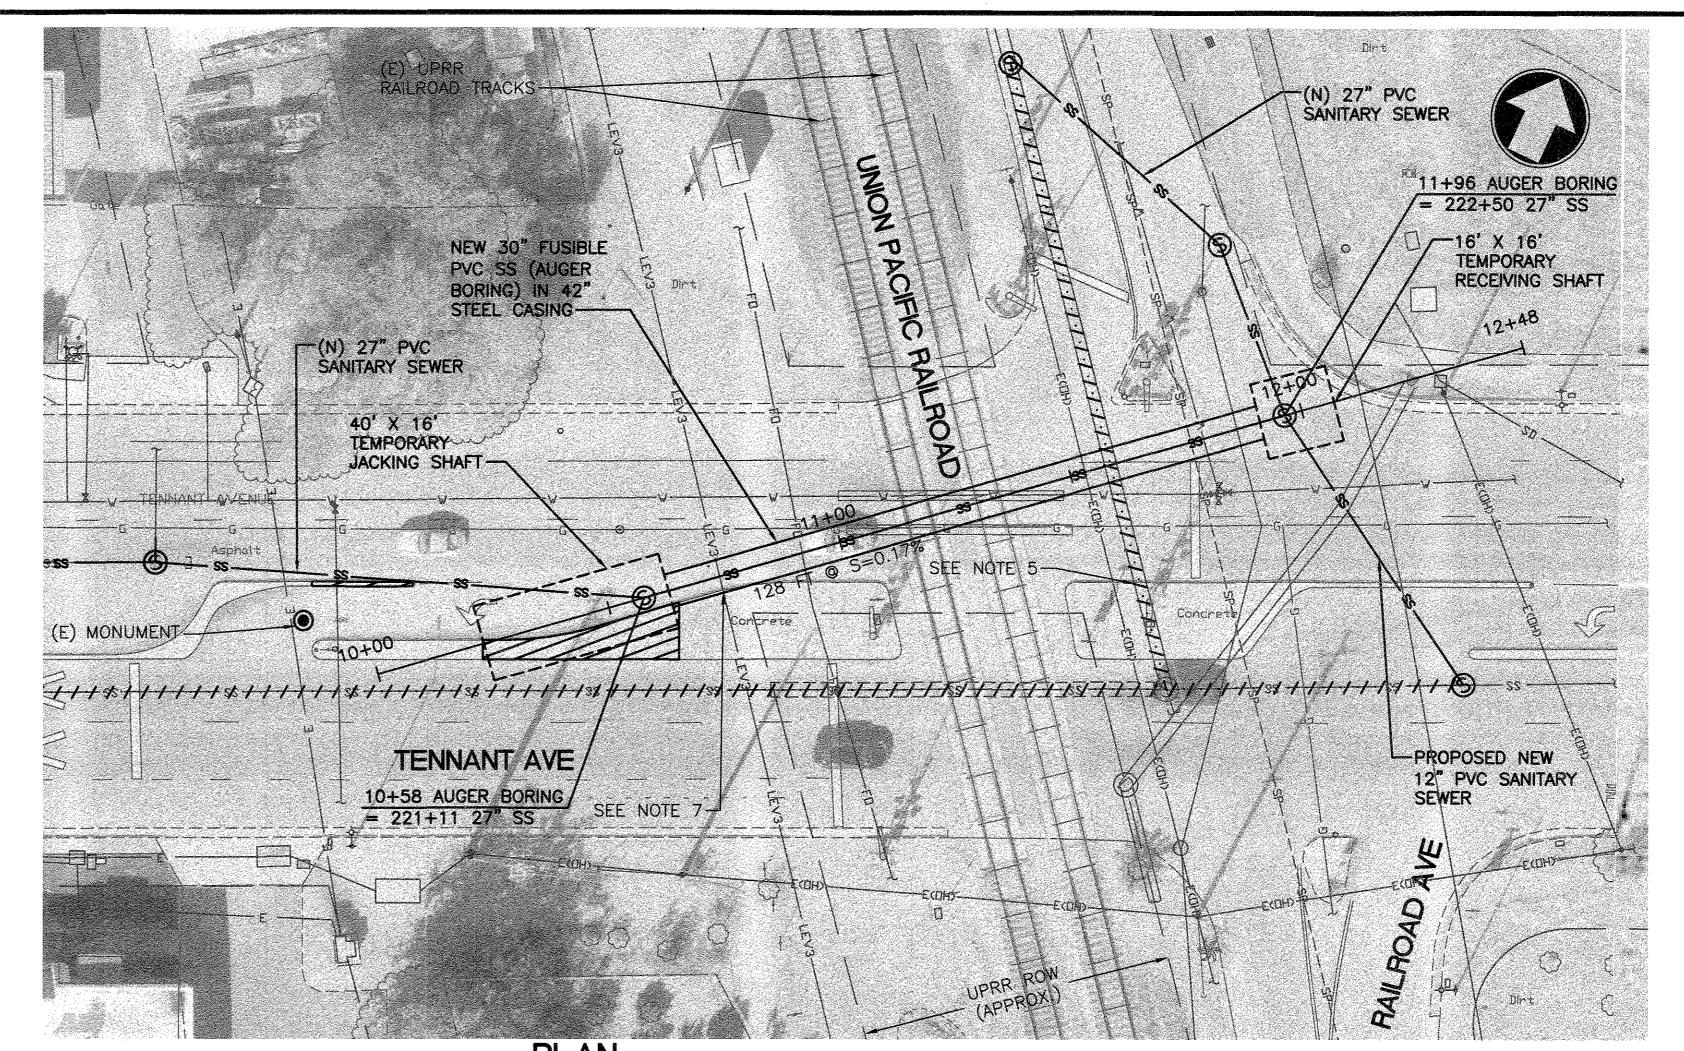

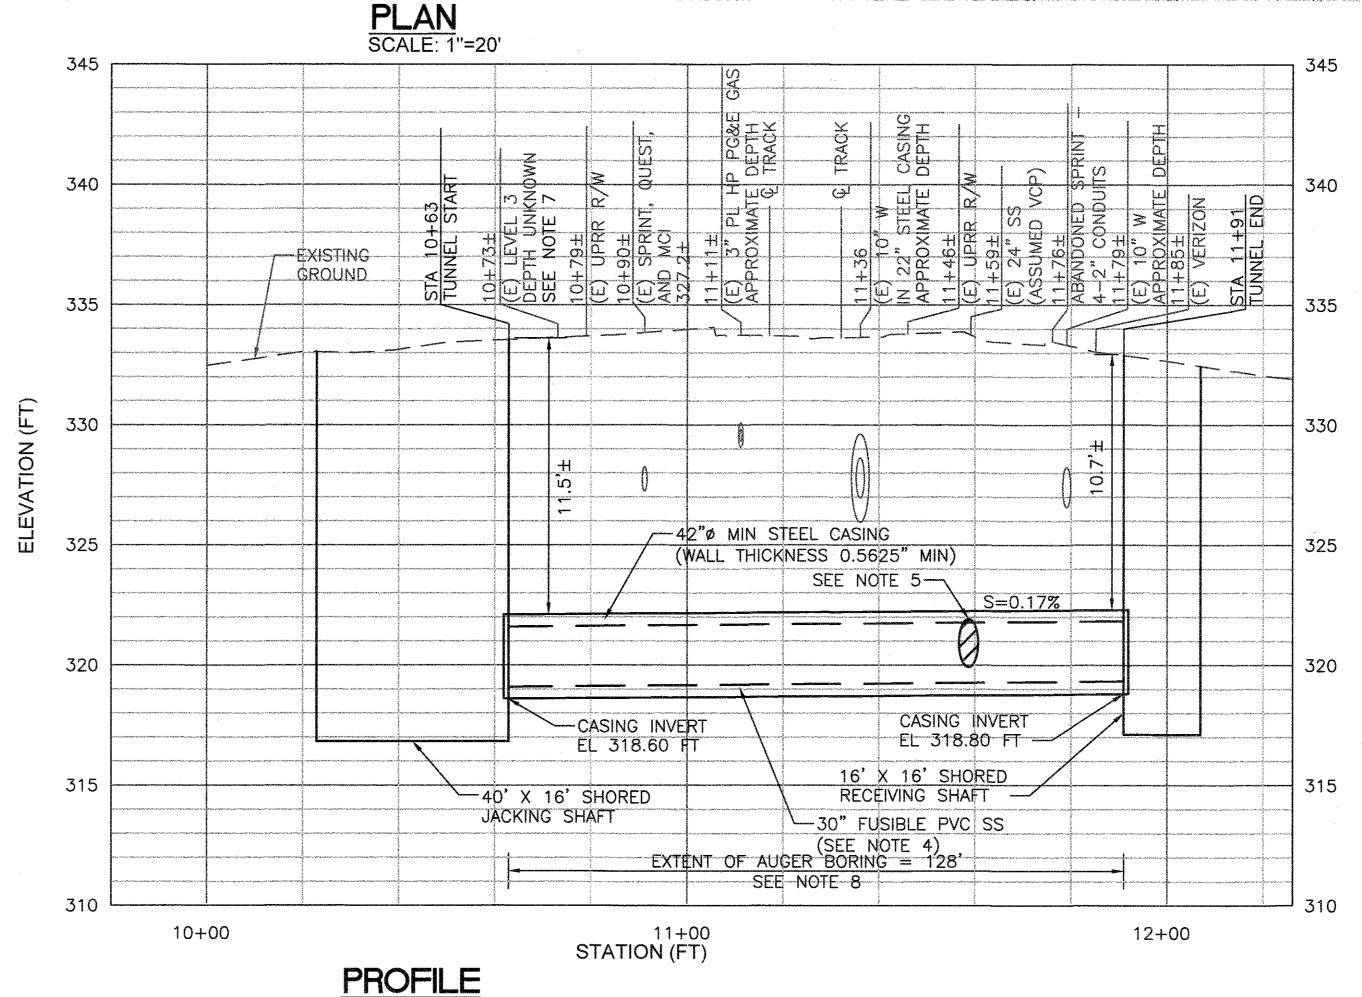

WORK ACCEPTED: INSPECTOR: 1"=20' AHVERT: 1"=4' CHECKED: AS-BUILT CORRECTIONS DG APPROVED: JOB NUMBER: DATE BY DESCRIPTION DATE: 376483 Revisions

CITYENGR SCOTT CREER RCE 58879 EXP. 06/30/19



City of Morgan Hill **Public Works Department** 100 Edes Ct. Morgan Hill, CA 95037 (408)776-7337, Fax (408)779-6282

SCALE: 1"=20' HORIZ

1"=4' VERT


MOTT MACDONALD

2077 GATEWAY PLACE SUITE 550 SAN JOSE, CA 95110 WWW.MOTTMAC.COM

TUNNEL CROSSING TENNANT AVENUE SEWER MAIN PROJECT


C78299 Exp. <u>9-30-19</u> FILE NUMBER:

302T17 PRINT DATE: 6/5/2019 SHEET NUMBER: **C-6** 10 OF 19

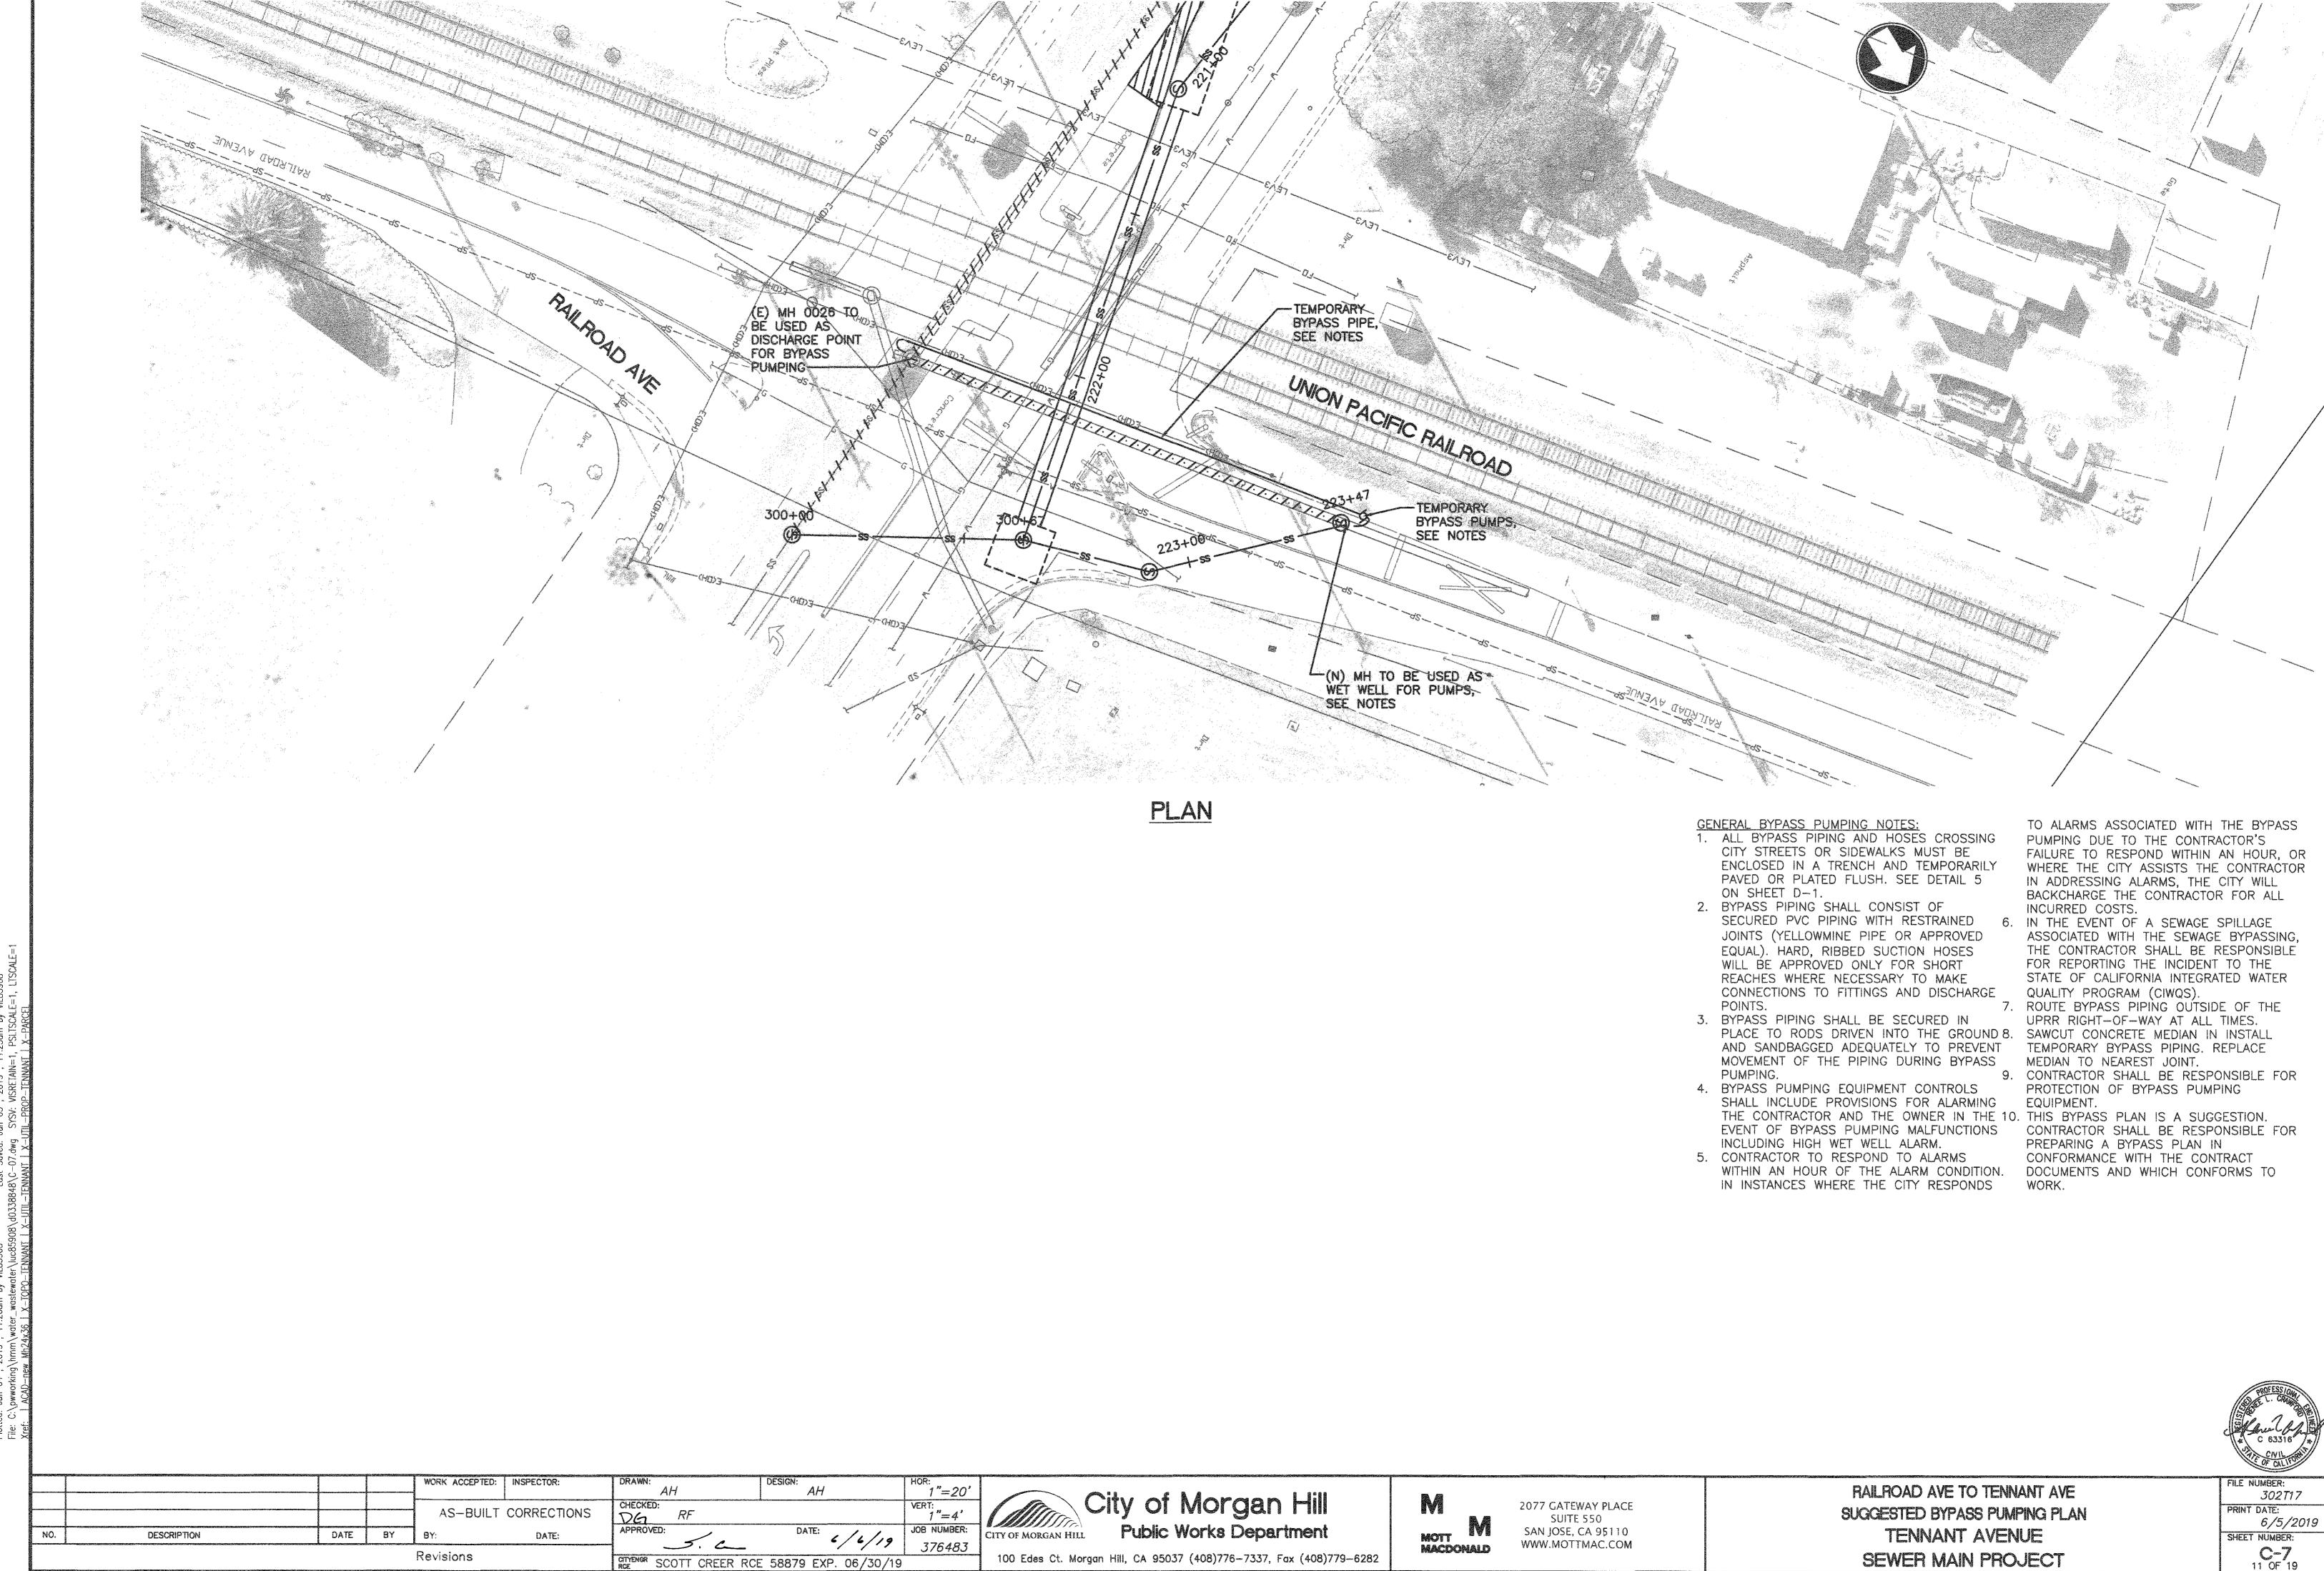

SEWER MAIN PROJECT

C-7 11 OF 19

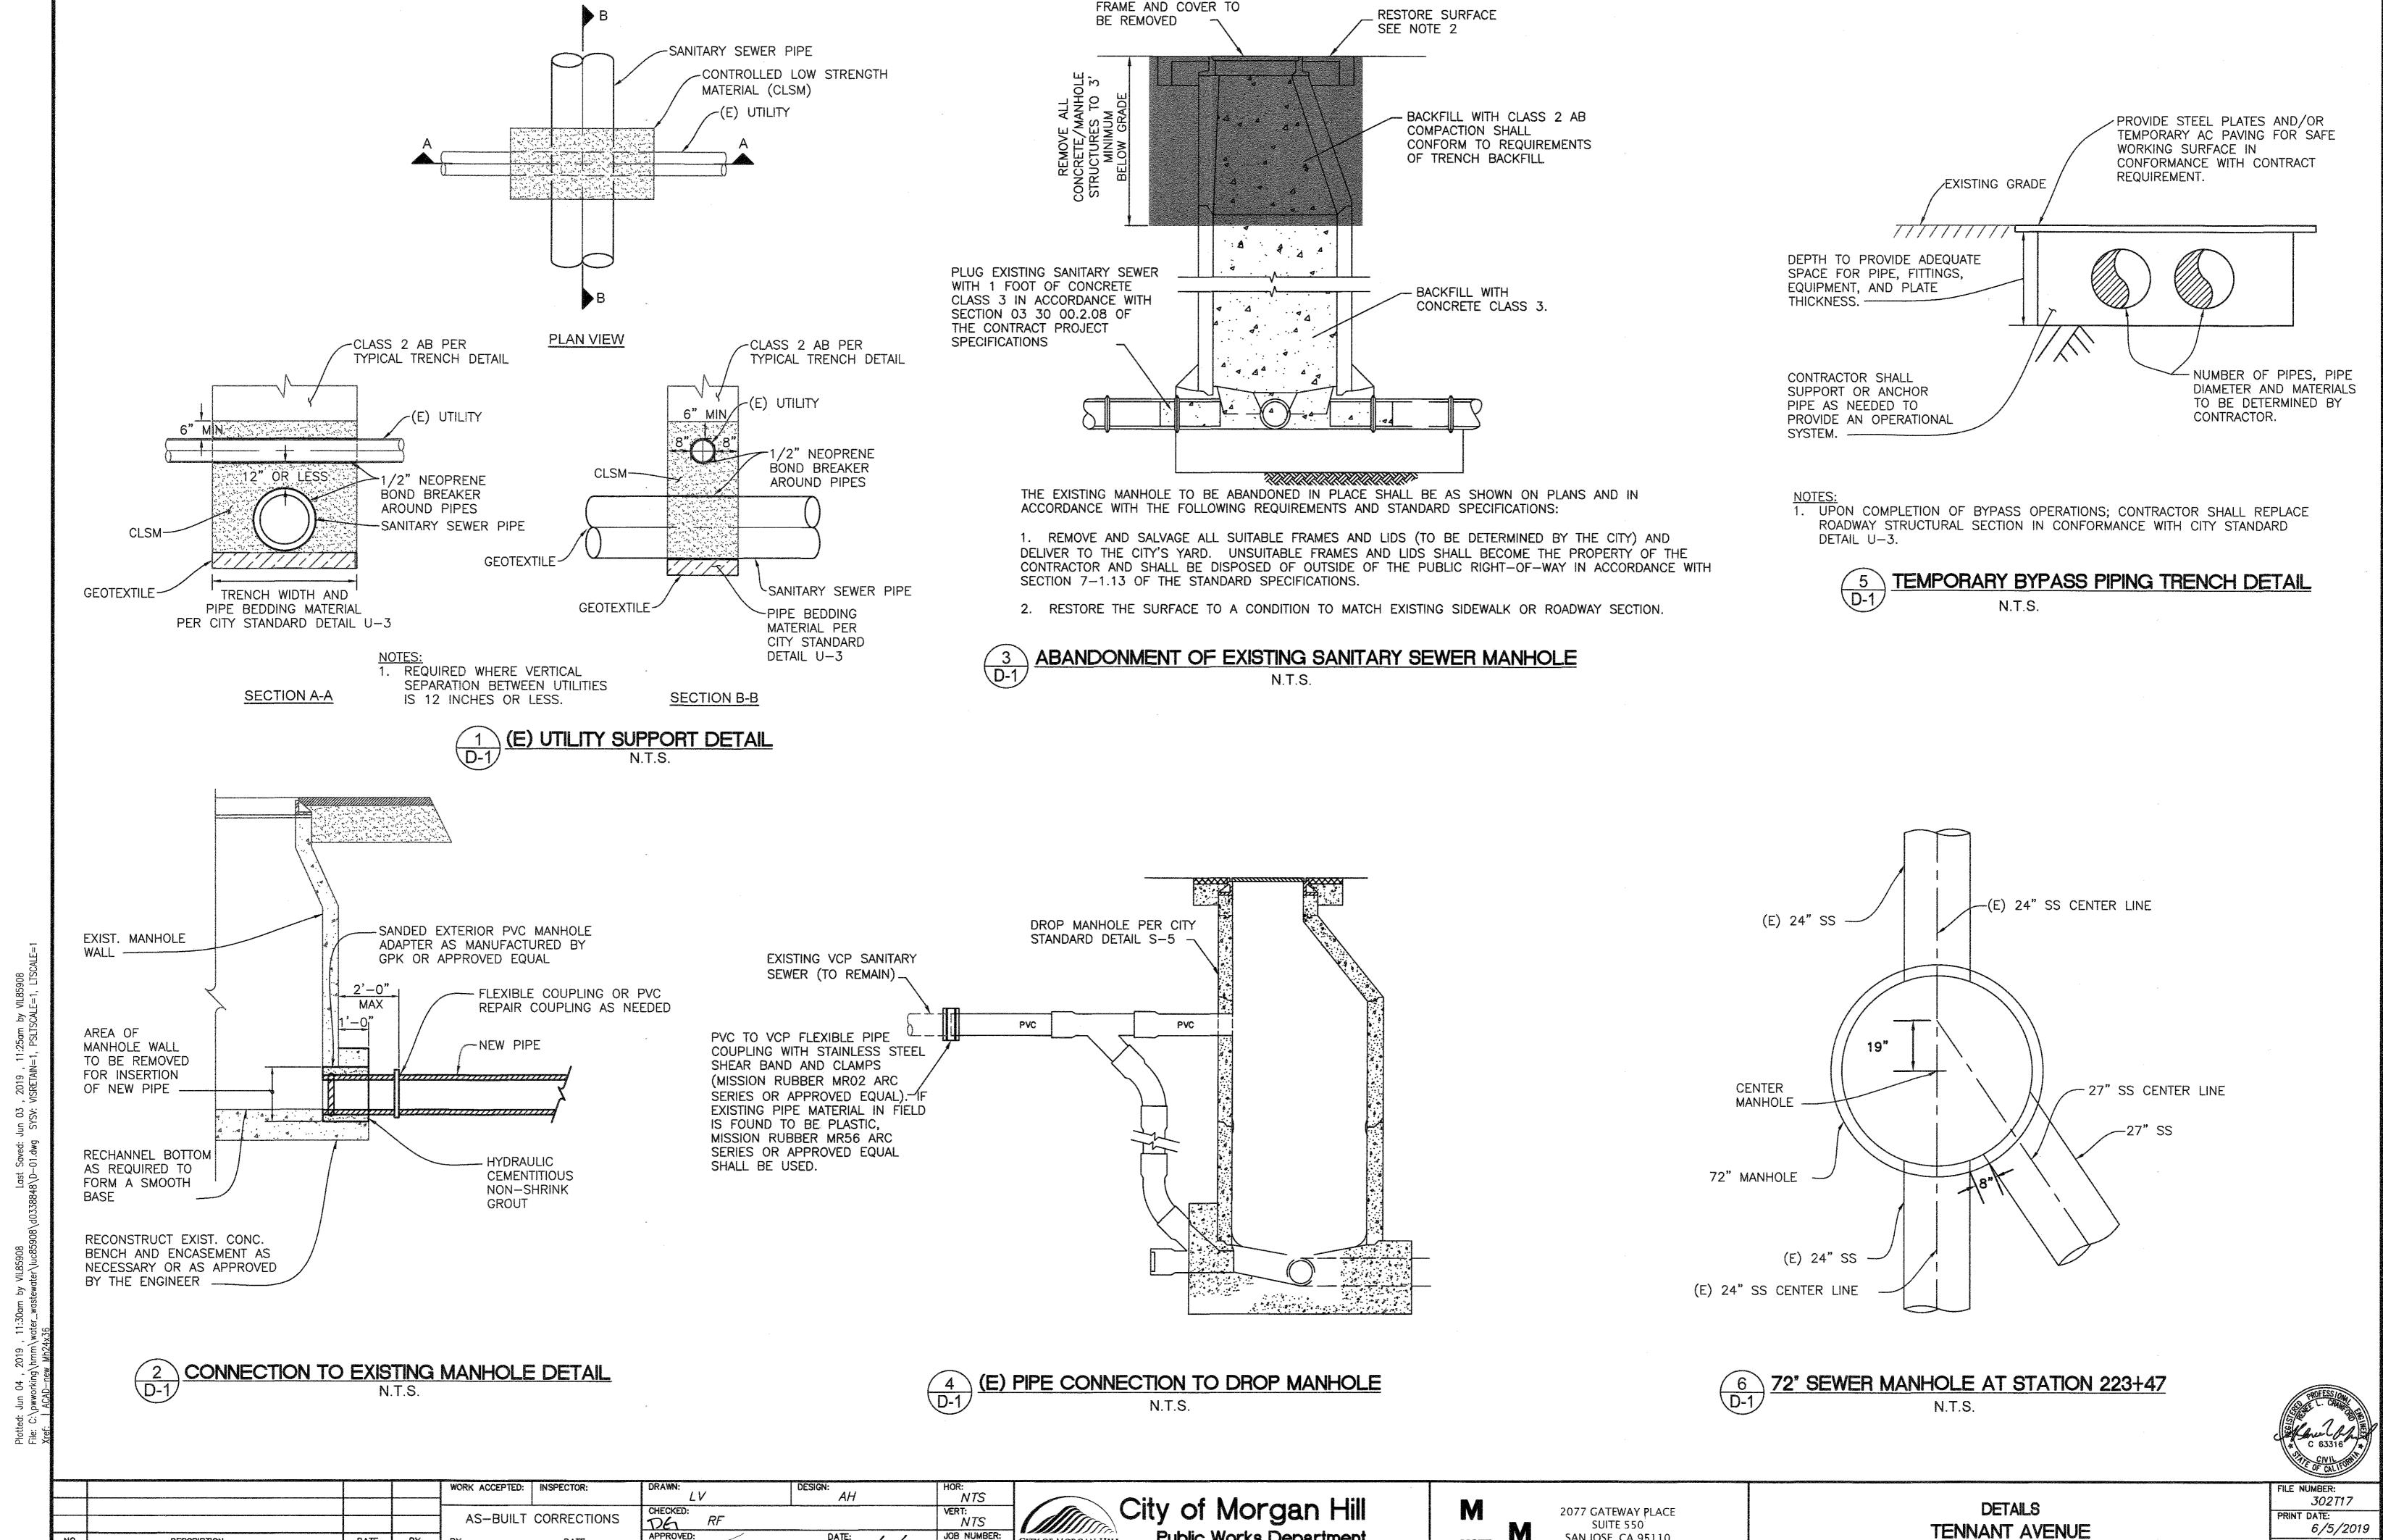

Public Works Department

100 Edes Ct. Morgan Hill, CA 95037 (408)776-7337, Fax (408)779-6282

SAN JOSE, CA 95110

WWW.MOTTMAC.COM

MOTT MACDONALD

JOB NUMBER:

376483

CITY OF MORGAN HILL

APPROVED:

CITYENGR SCOTT CREER RCE 58879 EXP. 06/30/19

DESCRIPTION


DATE

BY

Revisions

6/5/2019 SHEET NUMBER: **D-1**12 OF 19

SEWER MAIN PROJECT

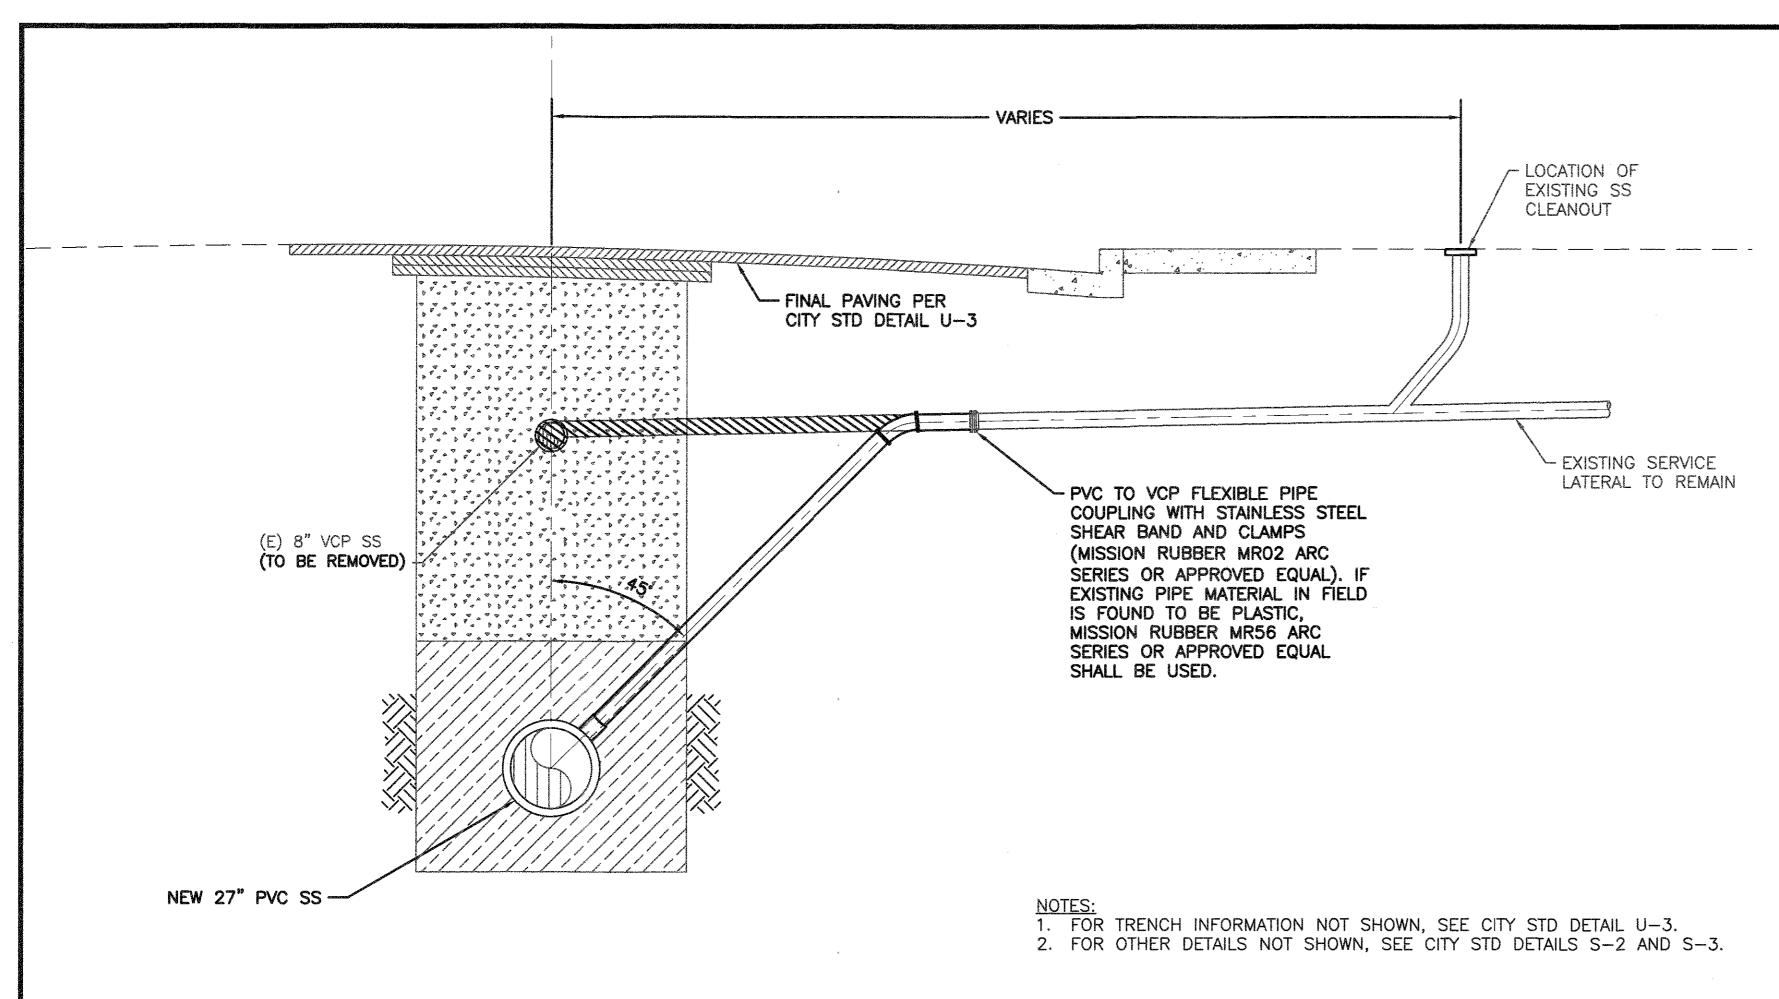

TYPICAL SECTION VIEW OF ALTERNATE SS LATERAL INSTALLATION

N.T.S.

LV

5. 6_

CITYENGR SCOTT CREER RCE 58879 EXP. 06/30/19

CHECKED:

126

APPROVED:

AS-BUILT CORRECTIONS

BY

Revisions

DATE

DESCRIPTION

AH


NTS

NTS

JOB NUMBER:

376483

CITY OF MORGAN HILL

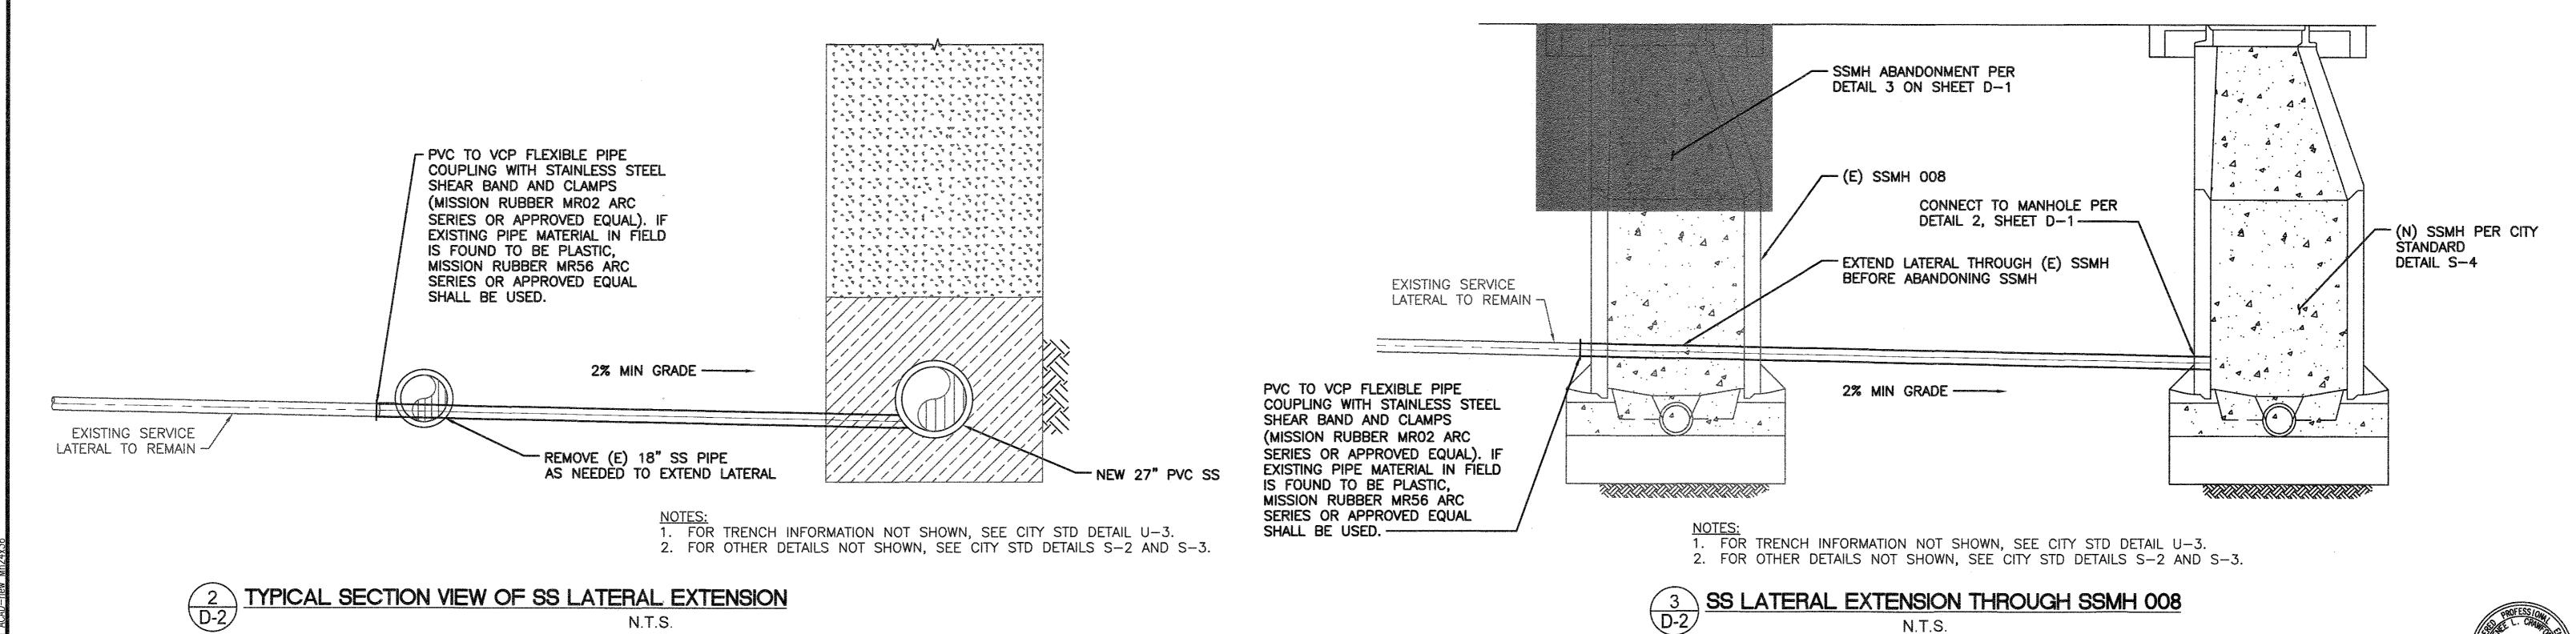

City of Morgan Hill

100 Edes Ct. Morgan Hill, CA 95037 (408)776-7337, Fax (408)779-6282

Public Works Department

2077 GATEWAY PLACE

SUITE 550

SAN JOSE, CA 95110

WWW.MOTTMAC.COM

MACDONALD

302T17

6/5/2019

PRINT DATE:

SHEET NUMBER:


D-2 13 OF 19


DETAILS


TENNANT AVENUE


SEWER MAIN PROJECT


Plotted: Jun 04 , 2019 , 11:30am by VIL85908 Last Saved: Jun 03 , 2019 , 11:59am by VIL8590 File: C:\pwworking\hmm\water_wastewater\luc85908\d0338848\D-02.dwg SYSV: VISRETAIN=1, PSLTSCALE=1, L

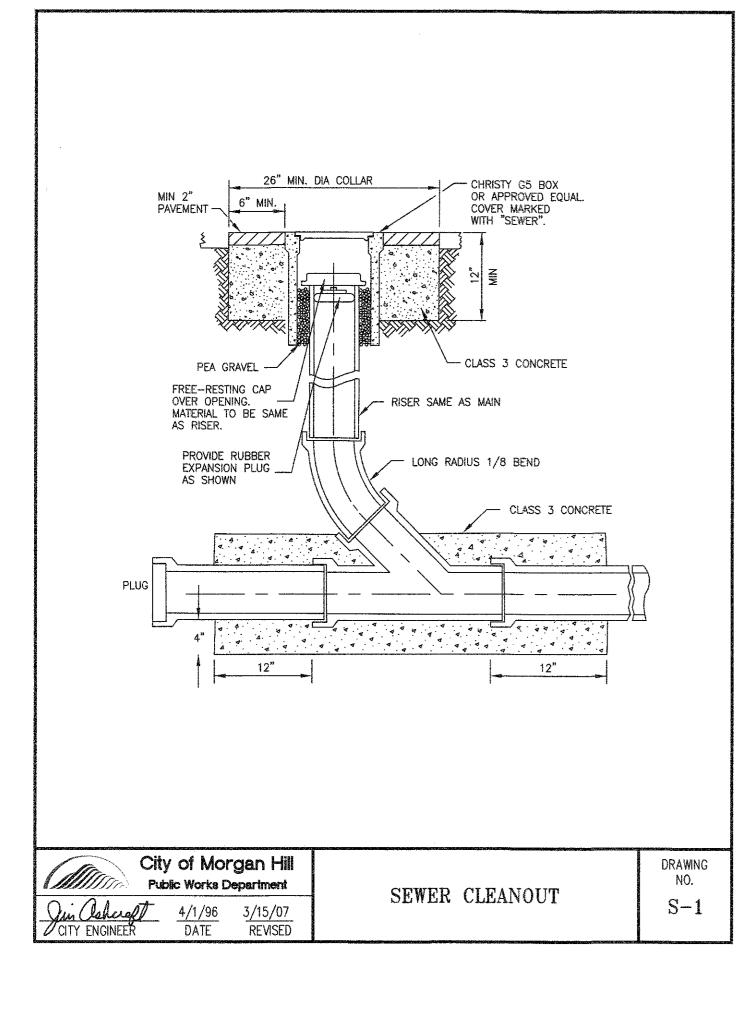


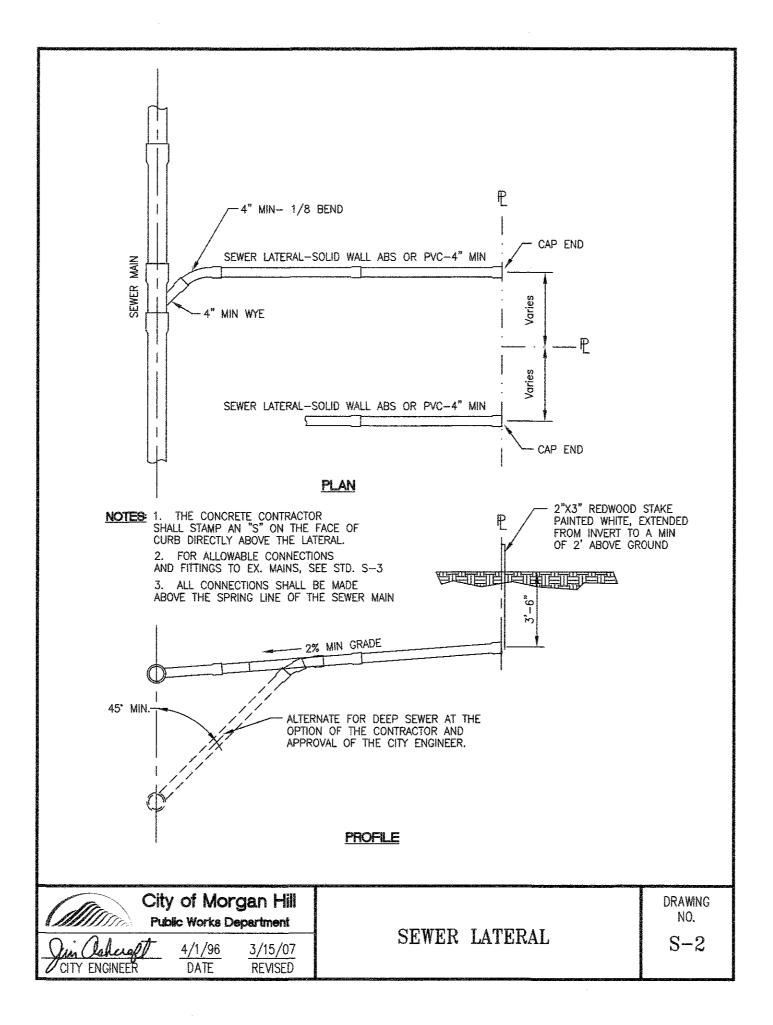


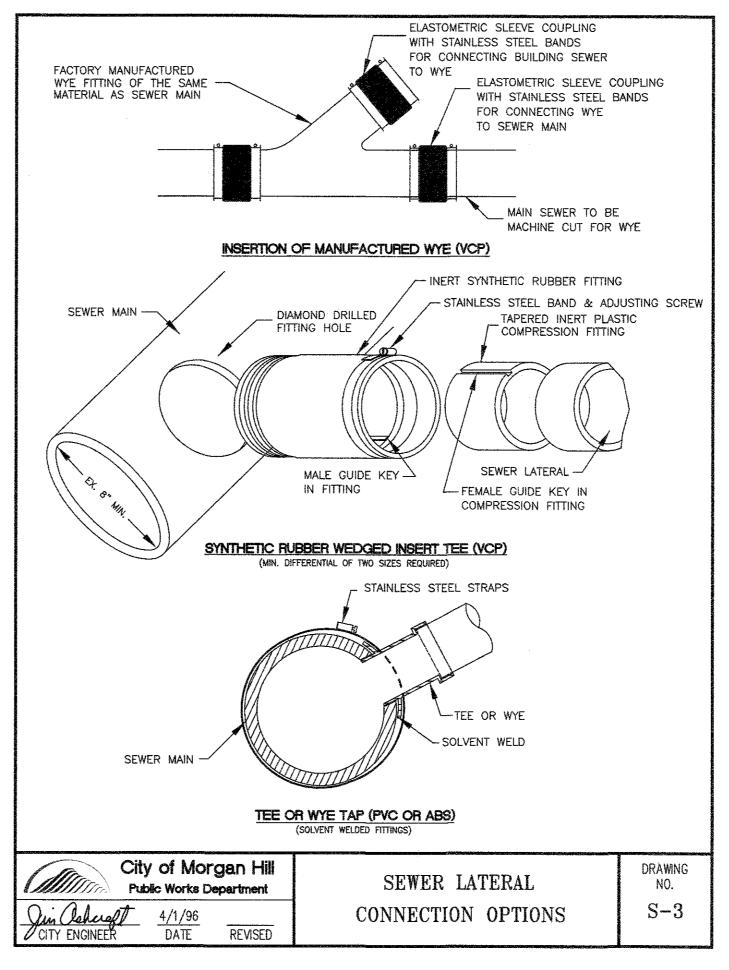


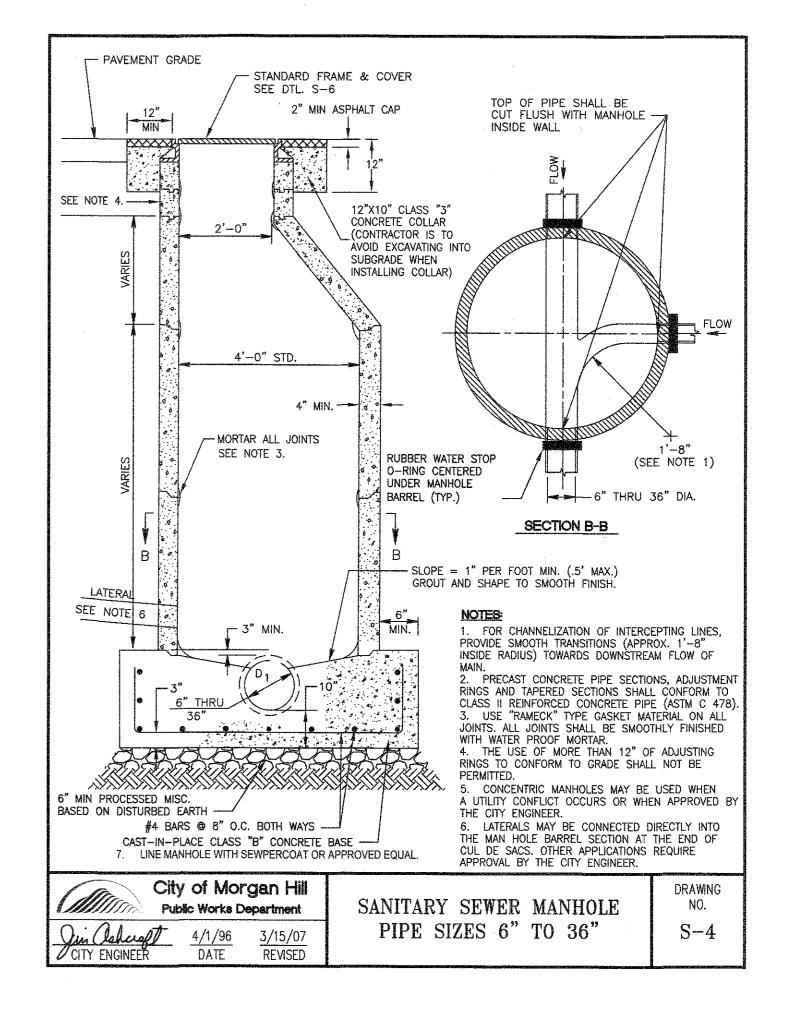


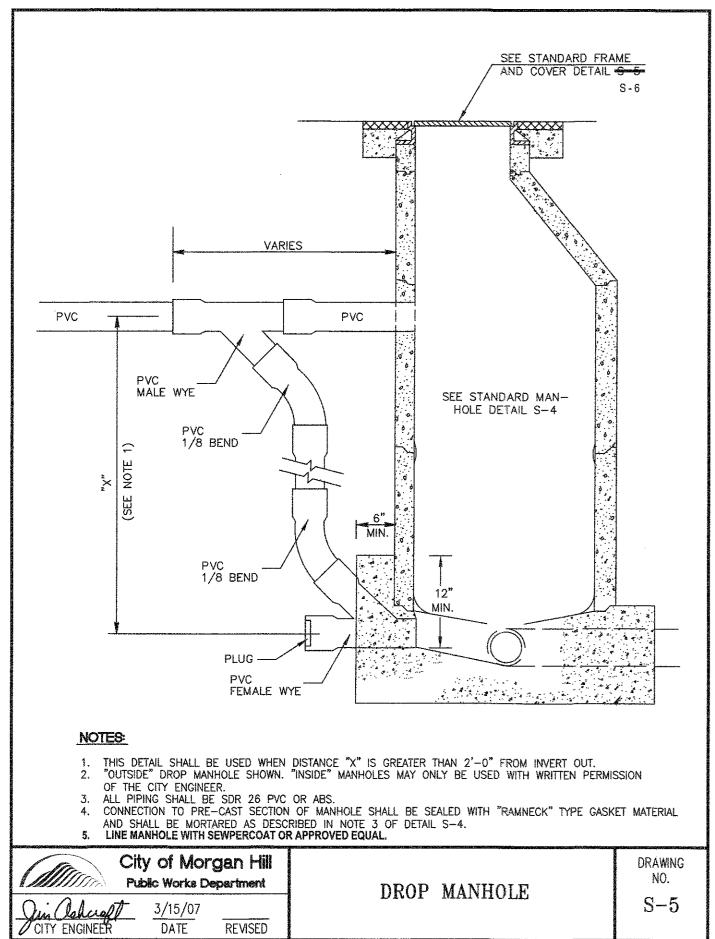


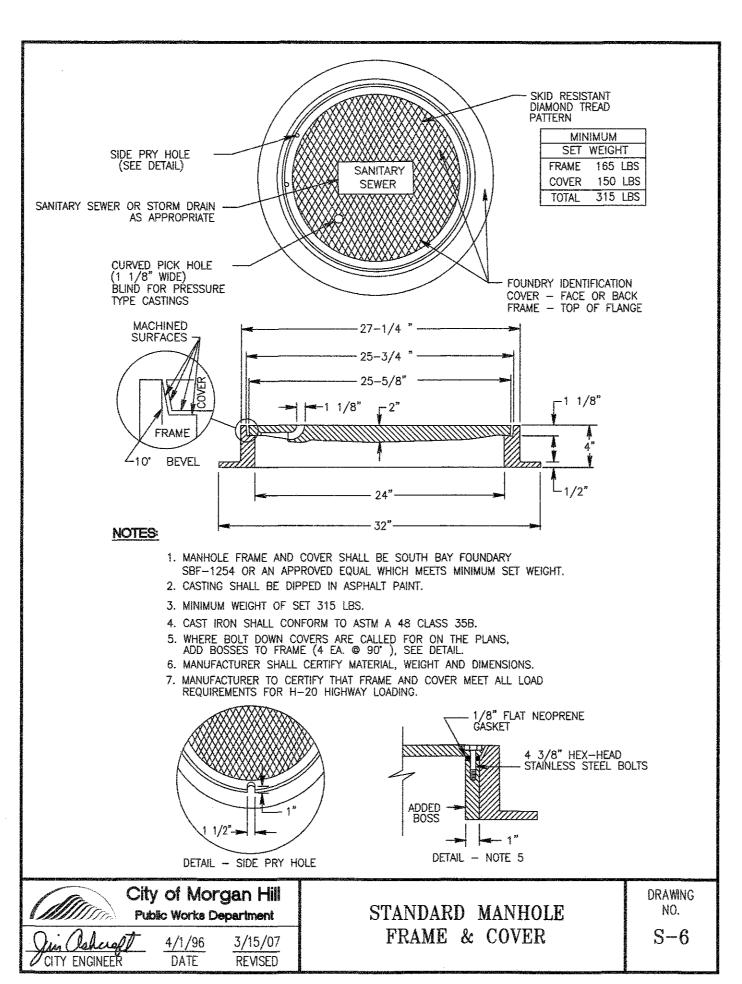

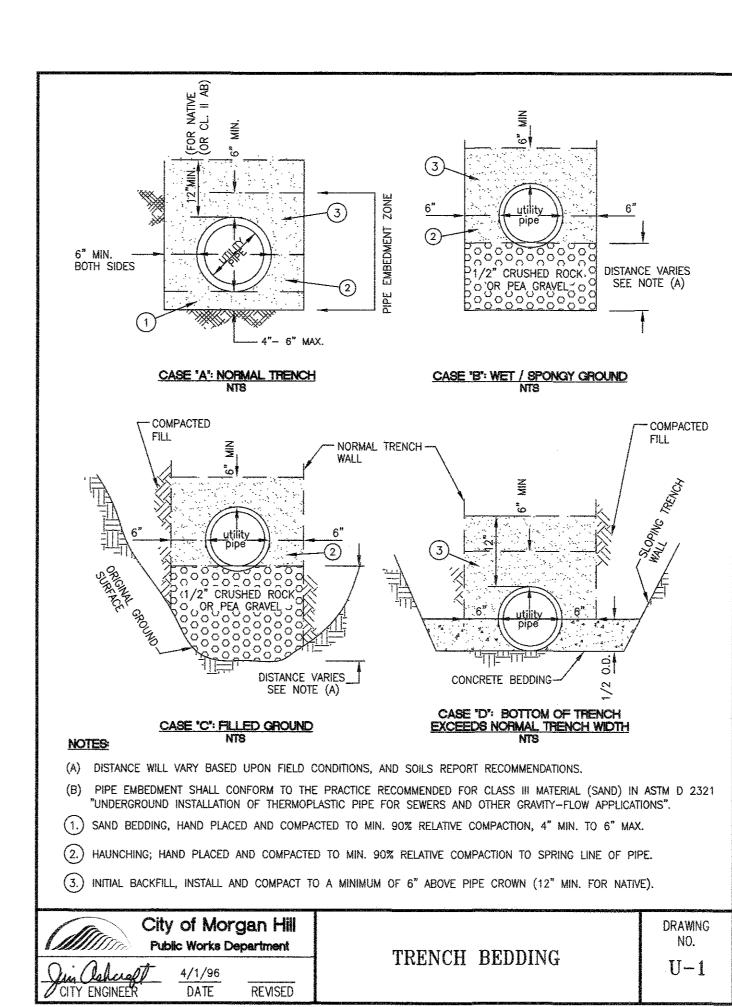

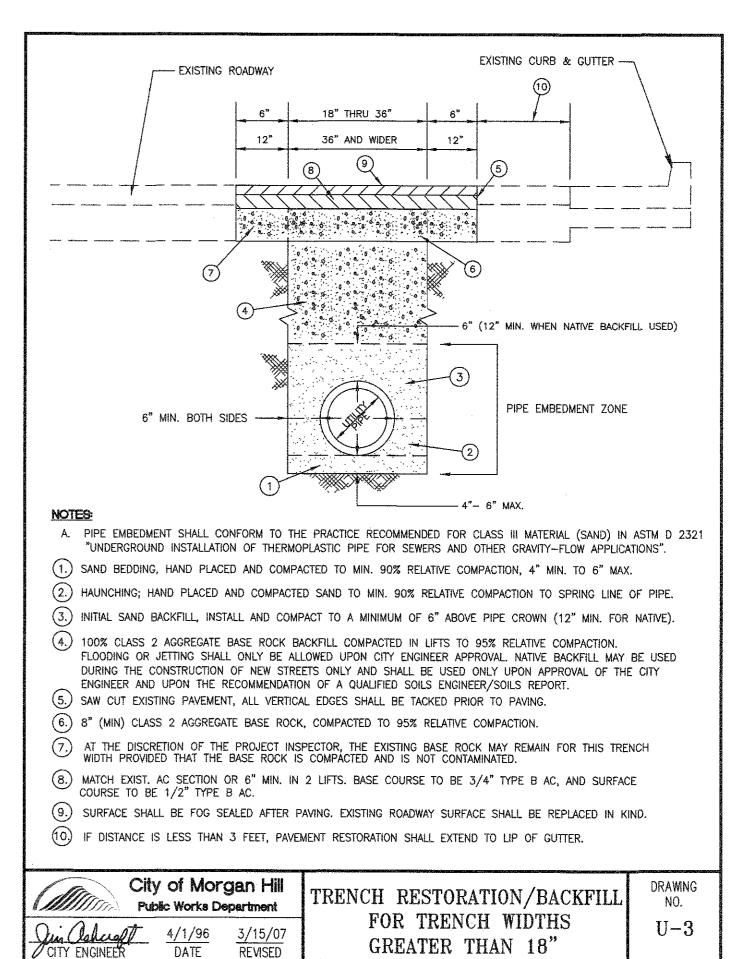

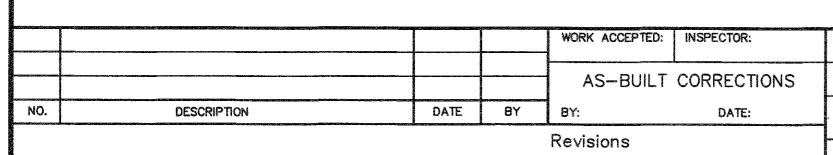

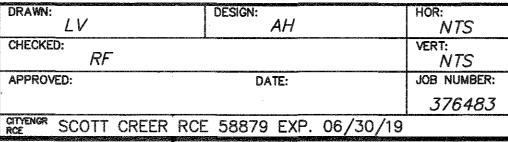



City of Morgan Hill Public Works Department 100 Edes Ct. Morgan Hill, CA 95037 (408)776-7337, Fax (408)779-6282

MOTT MACDONALD

2077 GATEWAY PLACE SUITE 550 SAN JOSE, CA 95110 WWW.MOTTMAC.COM

CITY STANDARD DETAILS TENNANT AVENUE SEWER MAIN PROJECT

FILE NUMBER: 302T17 6/5/2019 SHEET NUMBER: D-3

- 2. THE CONTRACTOR SHALL INSTALL TRAFFIC CONTROL DEVICES PRIOR TO COMMENCEMENT OF CONSTRUCTION. THE CONTRACTOR SHALL ALSO MAINTAIN ALL TRAFFIC CONTROL DEVICES DURING CONSTRUCTION, AS REQUIRED BY THE CITY ENGINEER/INSPECTOR. A 24-HOUR "ON-CALL" TELEPHONE NUMBER SHALL ALSO BE PROVIDED TO THE CITY BY THE CONTRACTOR FOR SERVICES REQUIRED BEYOND NORMAL WORKDAY OPERATIONS.
- 3. ACTUAL SIGN INSTALLATION LOCATIONS ARE TO BE DETERMINED IN THE FIELD. SIGN LOCATIONS SHALL BE APPROVED BY THE CITY ENGINEER/INSPECTOR PRIOR TO ANY INSTALLATION WORK.
- 4. SIGNS SHALL BE INSTALLED/PLACED AND REMOVED BY THE CONTRACTOR IN ACCORDANCE WITH THESE PLANS AND AS DIRECTED BY THE CITY.
- 5. ANY EXISTING SIGNS, STRIPING, AND/OR PAVEMENT MARKINGS THAT CONFLICT WITH THESE TRAFFIC CONTROL PLANS SHALL BE COVERED OR REMOVED DURING CONSTRUCTION. REMOVAL OF ROADWAY STRIPING AND/OR PAVEMENT MARKINGS SHALL BE DONE IN ACCORDANCE WITH CURRENT CALTRANS AND CA MUTCD STANDARDS. SIGNS, STRIPING, AND/OR PAVEMENT MARKINGS SHALL BE RESTORED TO EXISTING CONDITIONS TO THE SATISFACTION OF THE CITY ENGINEER/INSPECTOR ONCE CONSTRUCTION IS COMPLETE.
- 6. CONTRACTOR SHALL PROVIDE MINIMUM TWO (2) 10' WIDE TRAVEL LANE DURING CONSTRUCTION UNLESS OTHERWISE SHOWN ON PLANS.
- 7. TEMPORARY TRAFFIC CONTROL DEVICES SHALL NOT BLOCK FIRE HYDRANTS AND/OR DRIVEWAYS.
- 8. ALL TRAFFIC CONTROL DEVICES (SIGNS, CHANNELIZERS, ETC.) SHALL BE RETROREFLECTIVE AND/OR ILLUMINATED DURING NIGHTTIME TRAFFIC CONTROL.
- CONTRACTOR SHALL POST TEMPORARY "NO PARKING" SIGNS ALONG ROADWAY FRONTAGE, WHERE APPLICABLE, A MINIMUM 48 HOURS PRIOR TO COMMENCEMENT OF WORK AND SHALL NOTIFY THE POLICE DEPARTMENT. SIGNS SHALL STATE DAYS AND HOURS WHEN RESTRICTIONS ARE IN EFFECT.
- 10. CONTRACTOR SHALL DISPLAY ON ITS BARRICADES COMPANY NAME AND 24-HOUR EMERGENCY TELEPHONE NUMBER IN CASE OF EMERGENCY CALLOUTS.
- 11. CONTRACTOR SHALL FURNISH, ERECT, AND MAINTAIN BARRICADES, LIGHTS, SIGNS, FLAGMEN, FENCING, AND OTHER SAFETY MEASURES TO GIVE ADEQUATE PROTECTION TO THE PUBLIC AT ALL TIMES.
- 12. THE PARKING OF ANY CONSTRUCTION-RELATED VEHICLES OR STORAGE OF ANY MATERIAL IS NOT ALLOWED ON A PUBLIC STREET OR SIDEWALK UNLESS APPROVED IN ADVANCE BY THE CITY ENGINEER
- 13. ANY TRAFFIC STRIPING, PAVEMENT MARKINGS, PAVEMENT SURFACE, ETC. DAMAGED OR DESTROYED BY CONTRACTOR'S WORK SHALL BE REPLACED BY CONTRACTOR TO THE SATISFACTION OF THE CITY ENGINEER AT CONTRACTOR'S SOLE EXPENSE. ANY DAMAGE TO CROSSWALK STRIPING LIMIT LINES AND PAVEMENT MARKINGS SHALL BE REPLACED IN ITS ENTIRETY.
- 14. FOR ANY ONGOING PROJECTS IN THE VICINITY OF THIS PROJECT, THE ROUTING OF PEDESTRIANS, VEHICLES, AND CONSTRUCTION TRUCKS SHALL BE COORDINATED WITH OTHER CONTRACTORS TO MINIMIZE PUBLIC INCONVENIENCE.
- 15. SIDEWALKS AND TRAFFIC LANES SHALL REMAIN OPEN WHEN NO ACTIVITY IS PLANNED AND/OR BETWEEN SCHEDULED CLOSURES. SIDEWALKS AND TRAFFIC LANES SHALL BE OPENED AT THE END OF EACH WORKDAY.
- 16. WHEN USED FOR VEHICULAR AND/OR PEDESTRIAN TRAFFIC CONTROL, STEEL PLATES SHALL BE INSTALLED FLUSH WITH ADJACENT
- 17. PROJECT CONTRACTOR SHALL DETERMINE ULTIMATE PROJECT PHASING AND ACTUAL DURATION OF EACH PHASE AND SHALL SUBMIT AN ACTIVITY DURATION TABLE TO THE CITY PUBLIC WORKS INSPECTOR PRIOR TO START OF CONSTRUCTION.
- 18. AT THE END OF EACH WORK DAY THE CONTRACTOR SHALL BE RESPONSIBLE FOR BACKFILLING THE TRENCHES AND PLACING TRAFFIC-RATED STEEL PLATES TO REOPEN THE TRAFFIC LANES TO TRAFFIC DURING NON-WORK HOURS. STEEL PLATES SHALL BE INSTALLED FLUSH WITH ADJACENT GRADE TO PROVIDE SMOOTH AND SAFE DRIVING CONDITIONS. IF PLATES ARE NOT RECESSED TO BE FLUSH WITH THE PAVEMENT, CONTRACTOR SHALL INSTALL TEMPORARY PAVING WITH COLD ASPHALT TO FEATHER THE EDGES OF THE STEEL PLATES. CONTRACTOR SHALL ADHERE TO SECTION 7-1.04, "PUBLIC SAFETY," OF THE 2018 CALTRANS STANDARD SPECIFICATIONS.
- 19. ALL PROPERTY OWNERS HALL BE NOTIFIED ONE WEEK IN ADVANCE OF ANY CONSTRUCTION THAT MAY AFFECT PROPERTY ACCESS. ACCESS TO ALL AFFECTED PROPERTIES SHALL BE MAINTAINED OPEN DURING CONSTRUCTION. UNLESS OTHERWISE NOTED.
- 20. SANDBAGS AND/OR GRAVEL BAGS SHALL BE PLACED OVER THE BASE LEGS OF BARRICADE-MOUNTED SIGNS TO PREVENT ANY OVERTURNING.
- 21. CONSTRUCTION ACTIVITIES AND TRAFFIC CONTROL MEASURES SHALL BE LIMITED TO THE HOURS BETWEEN 8:00 AM AND 4:00 PM. MONDAY THROUGH FRIDAY, UNLESS ALLOWED OTHERWISE BY THE CITY ENGINEER/INSPECTOR OR OTHERWISE NOTED BY PLANS.
- 22. CONTRACTOR SHALL MAINTAIN TRAFFIC SIGNAL DURING CONSTRUCTION. COORDINATE WITH CITY FOR ANY SIGNAL OPERATION MODIFICATION WORK.
- 23. THE CONTRACTOR SHALL NOTIFY THE ENGINEER AND POLICE DEPARTMENT 24 HOURS PRIOR TO ANY OPERATIONAL SHUTDOWN OF EXISTING SIGNAL SYSTEM.
- 24. CONTRACTOR TO PROVIDE UP TO FOUR (4) PORTABLE CHARGEABLE MESSAGE SIGNS (PCM) AS DIRECTED BY THE ENGINEER.

Revisions


25. THE TRAFFIC CONTROL PLANS SHOWN ARE FOR THE CONTRACTOR'S GUIDANCE ONLY. CONTRACTOR SHALL SUBMIT HIS OWN TRAFFIC CONTROL PLANS DEPENDING ON THE PHASING, MEANS AND METHODS OF CONSTRUCTION FOR REVIEW AND APPROVAL. THE TRAFFIC CONTROL PLANS SHALL BE PREPARED AND SIGNED BY A LICENSED TRAFFIC ENGINEER (TE) AND SHALL BE SUBMITTED NO LATER THAN TEN WORKING DAYS PRIOR TO COMMENCING CONSTRUCTION.

SIGN LEGEND

END ROAD WORK RIGHT LANE MUST TURN RIGHT





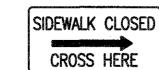

LANE CLOSED

G20-2 [36"x24"]

R3 - 7(R)[30"x30"]

W4-2(R)

[36"x36"]

R4-8 [24"x30"]

R6 - 1[36"x12"]

R9-11a [24"x12"]

SC11(CA) [42"x30"]



W4-2(L)[36"x36"]



SHARE THE ROAD [18"x24"] [36"x36"] LEFT LANE CLOSED AHEAD

W20-5L [36"x36"] RIGHT LANE CLOSED AHEAD W20-5R

[36"x36"]

LEGEND

- WORK ZONE

→ DIRECTION OF TRAFFIC

- - PORTABLE TRAFFIC SIGN

PORTABLE DELINEATORS @ 20' SPACING MAX.

- TYPE III BARRICADE (SIGN TYPE AS NOTED ON PLAN)

FLAGGER

- FLASHING ARROW SIGN

/ - PORTABLE CHANGEABLE MESSAGE SIGN (PCMS)

- PROTECTIVE BARRIERS

WORK ACCEPTED: MG1"=40' CHECKED: AS-BUILT CORRECTIONS JOB NUMBER: DATE BY DESCRIPTION 6/6/19 DATE: 5. Cm 376483

CITYENGR SCOTT CREER RCE 58879 EXP. 06/30/19





City of Morgan Hill Public Works Department 100 Edes Ct. Morgan Hill, CA 95037 (408)776-7337, Fax (408)779-6282

MACDONALD

2077 GATEWAY PLACE SUITE 550 SAN JOSE, CA 95110 WWW.MOTTMAC.COM

TRAFFIC CONTROL PLAN TENNANT AVENUE SEWER MAIN PROJECT

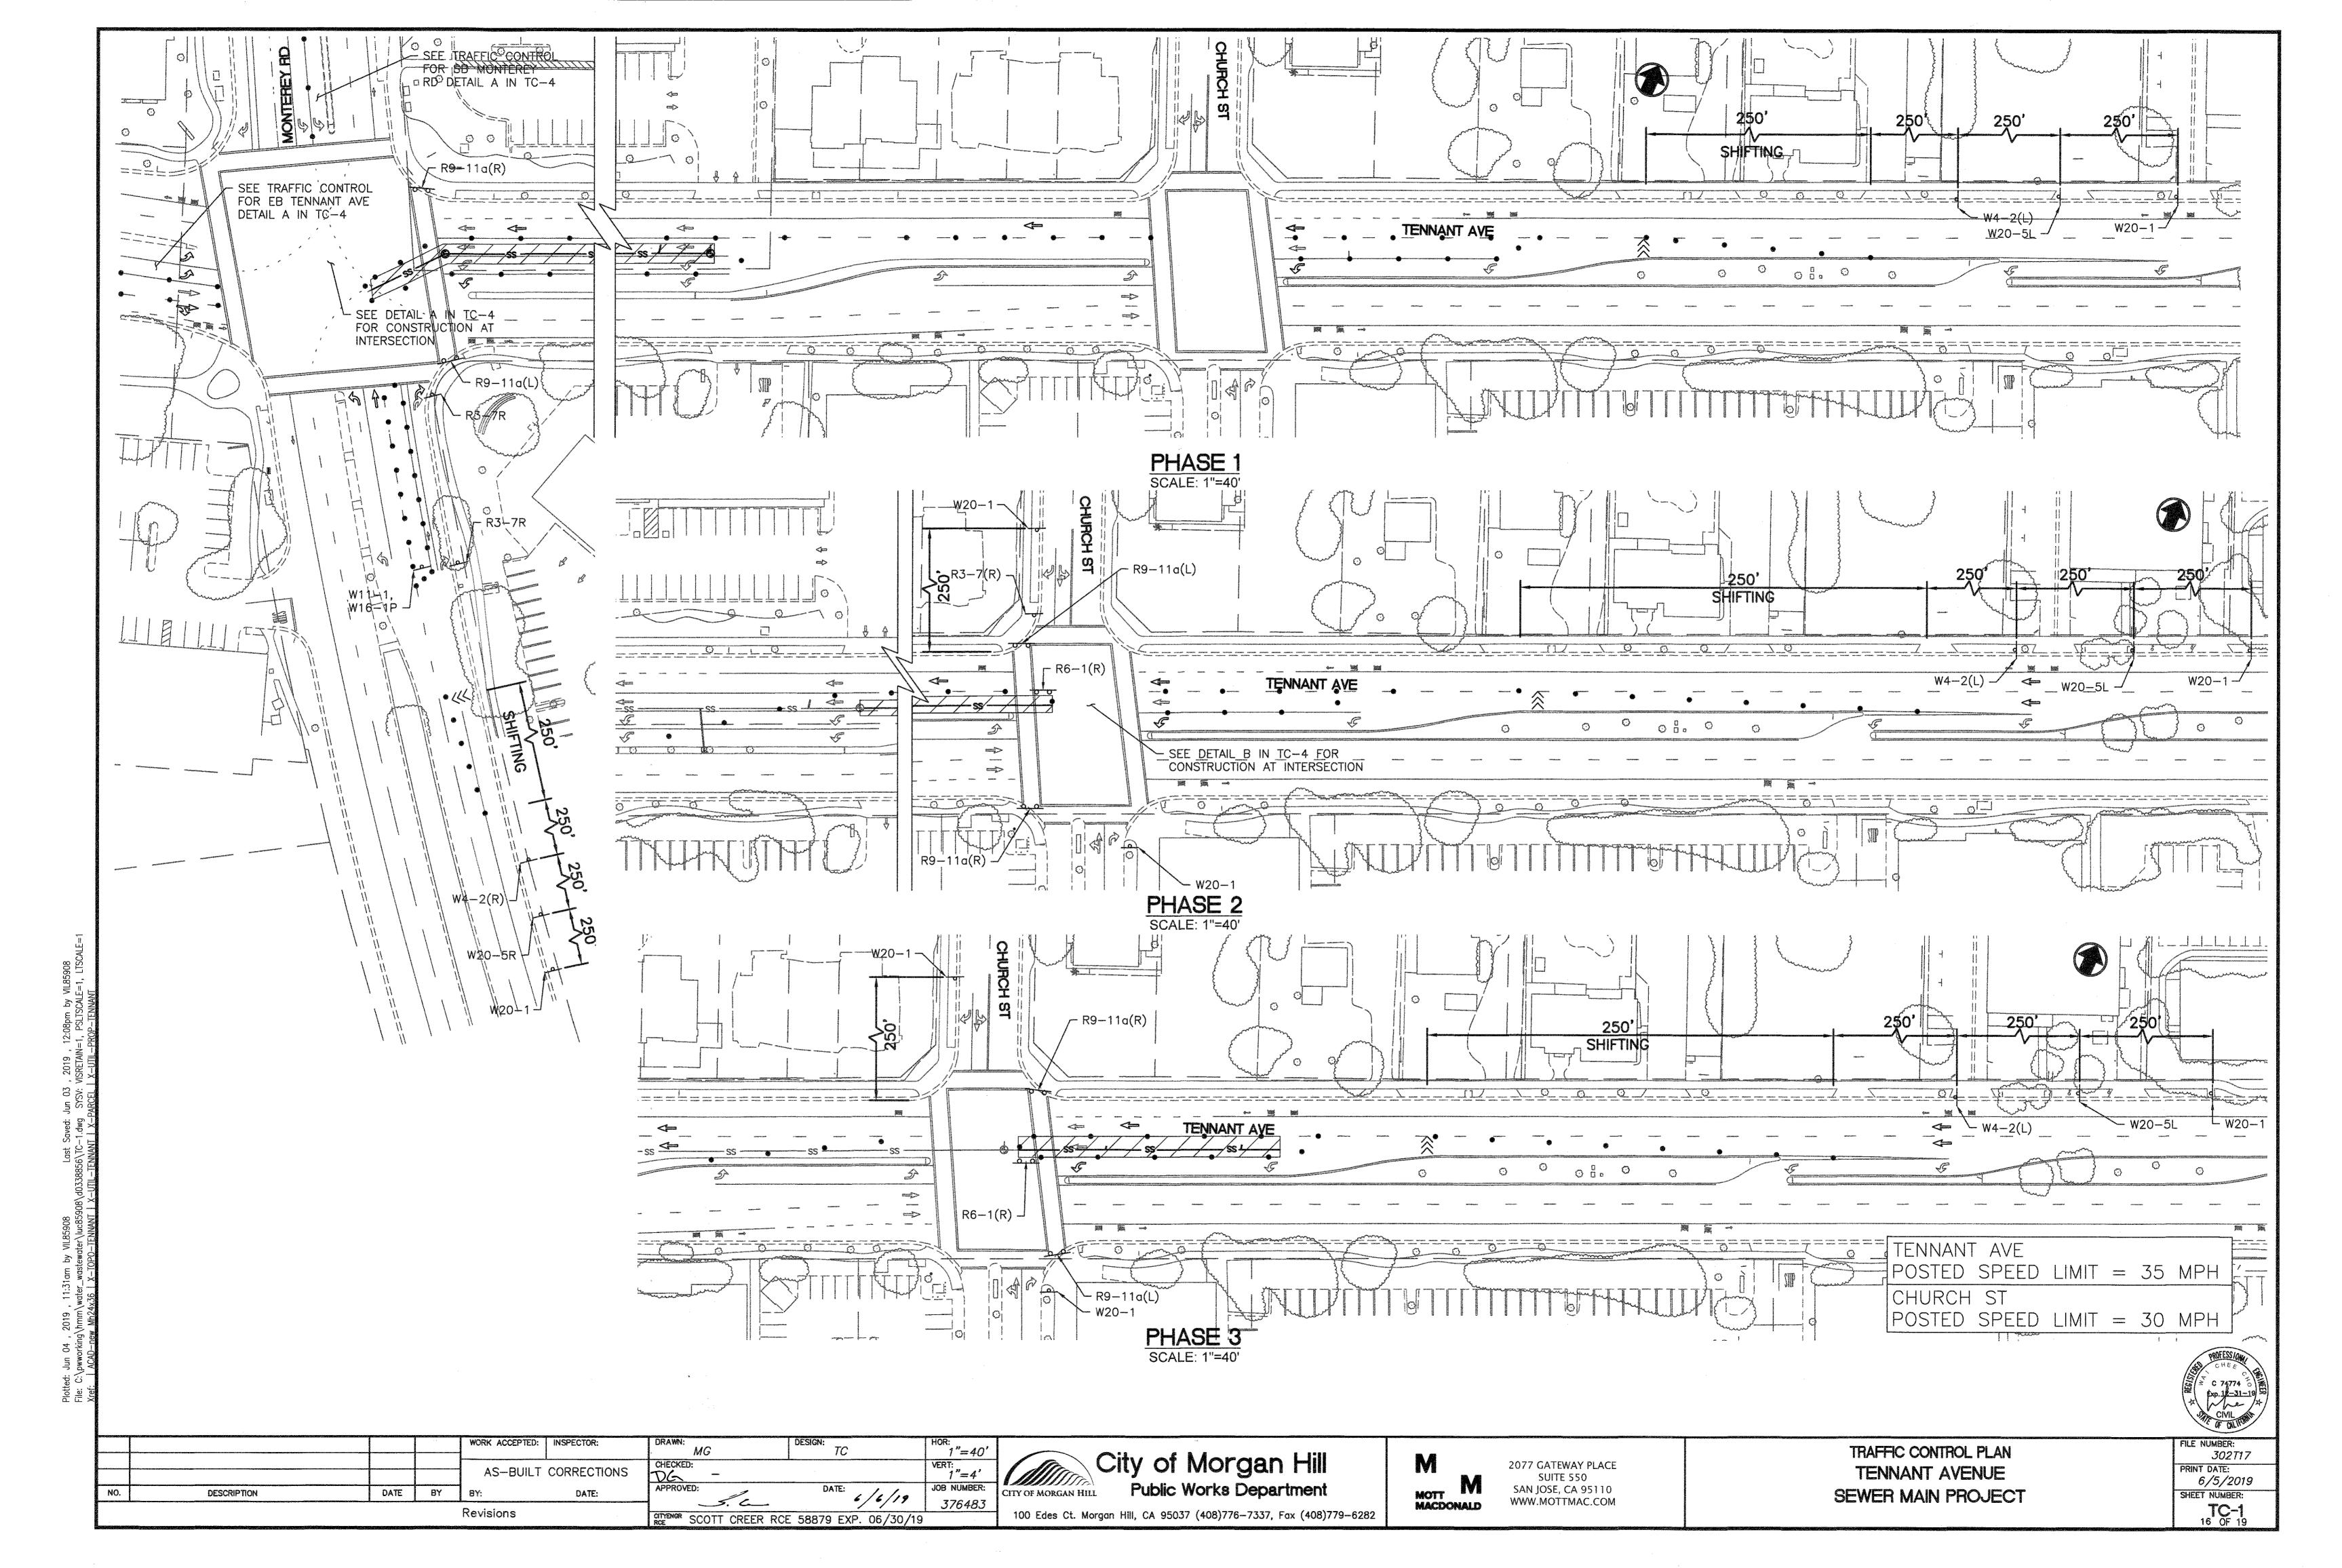

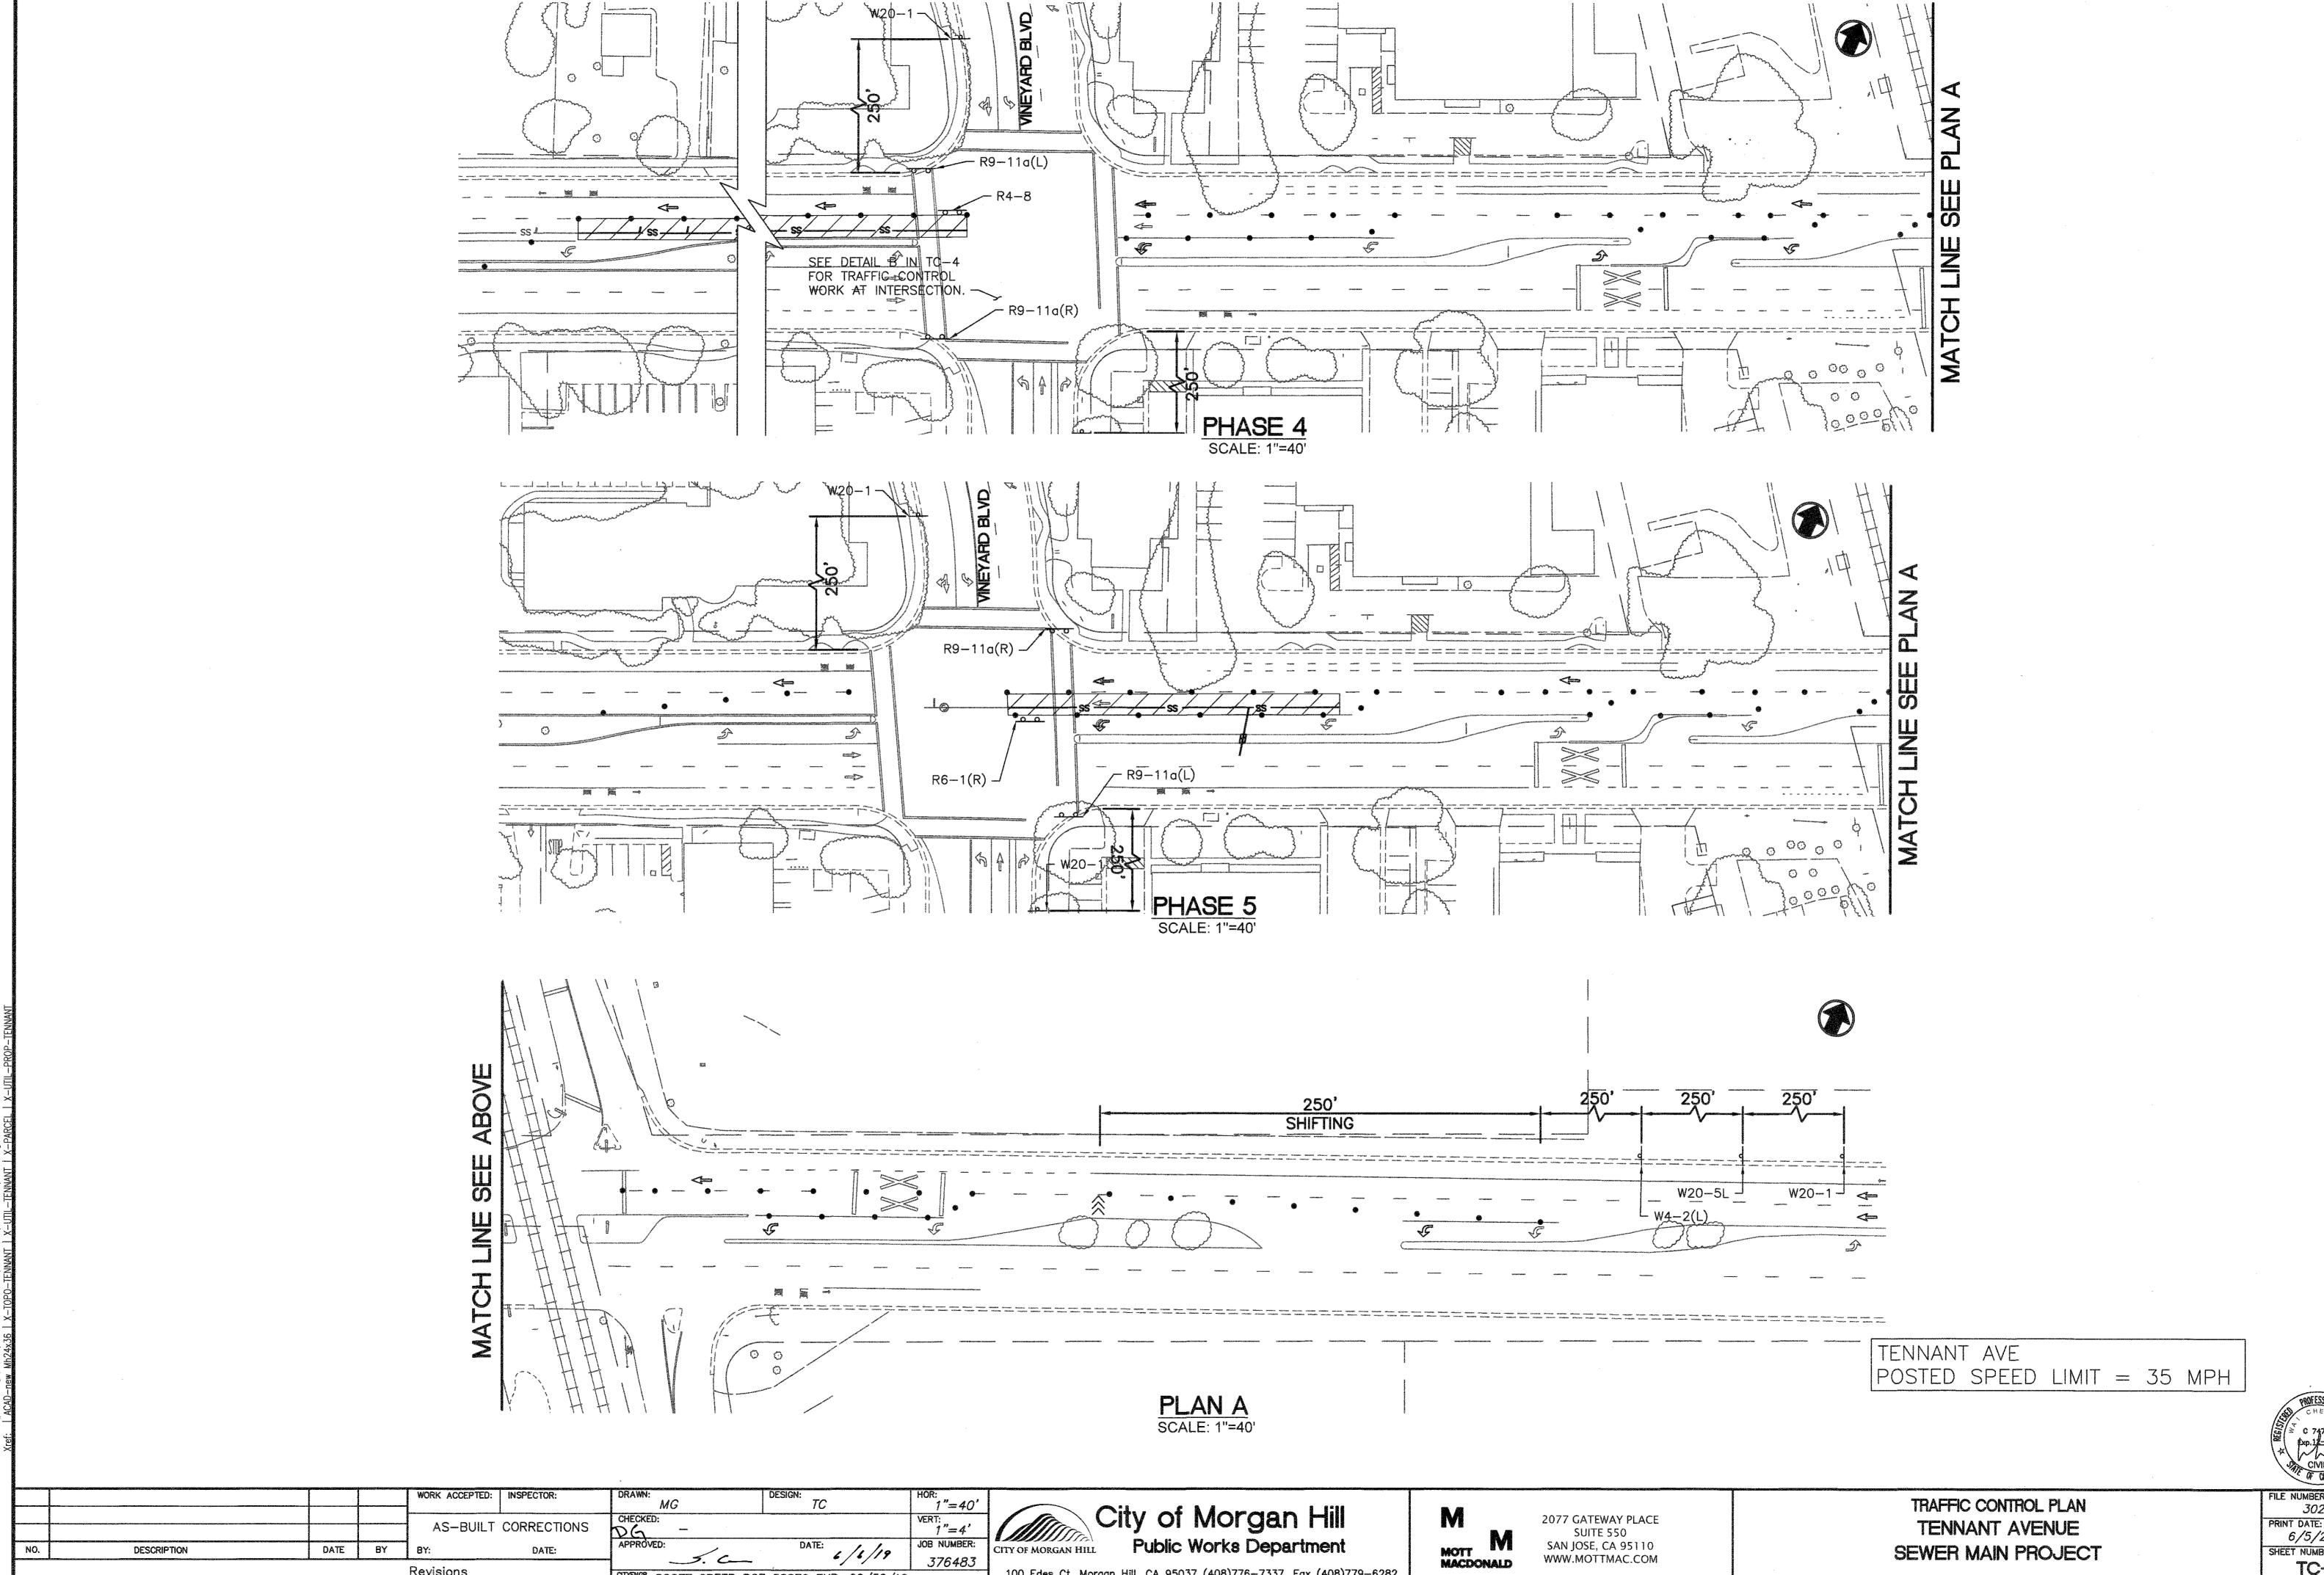

AS-BUILT CORRECTIONS

Revisions

DATE:

DATE BY

DESCRIPTION

DATE: 6/6/19

5. c—

CITYENGR SCOTT CREER RCE 58879 EXP. 06/30/19


MOTT BY I

Public Works Department


100 Edes Ct. Morgan Hill, CA 95037 (408)776-7337, Fax (408)779-6282

2077 GATEWAY PLACE SUITE 550 SAN JOSE, CA 95110 WWW.MOTTMAC.COM

TRAFFIC CONTROL PLAN TENNANT AVENUE SEWER MAIN PROJECT FILE NUMBER:
302T17
PRINT DATE:
6/5/2019
SHEET NUMBER: **TC-2** 17 OF 19

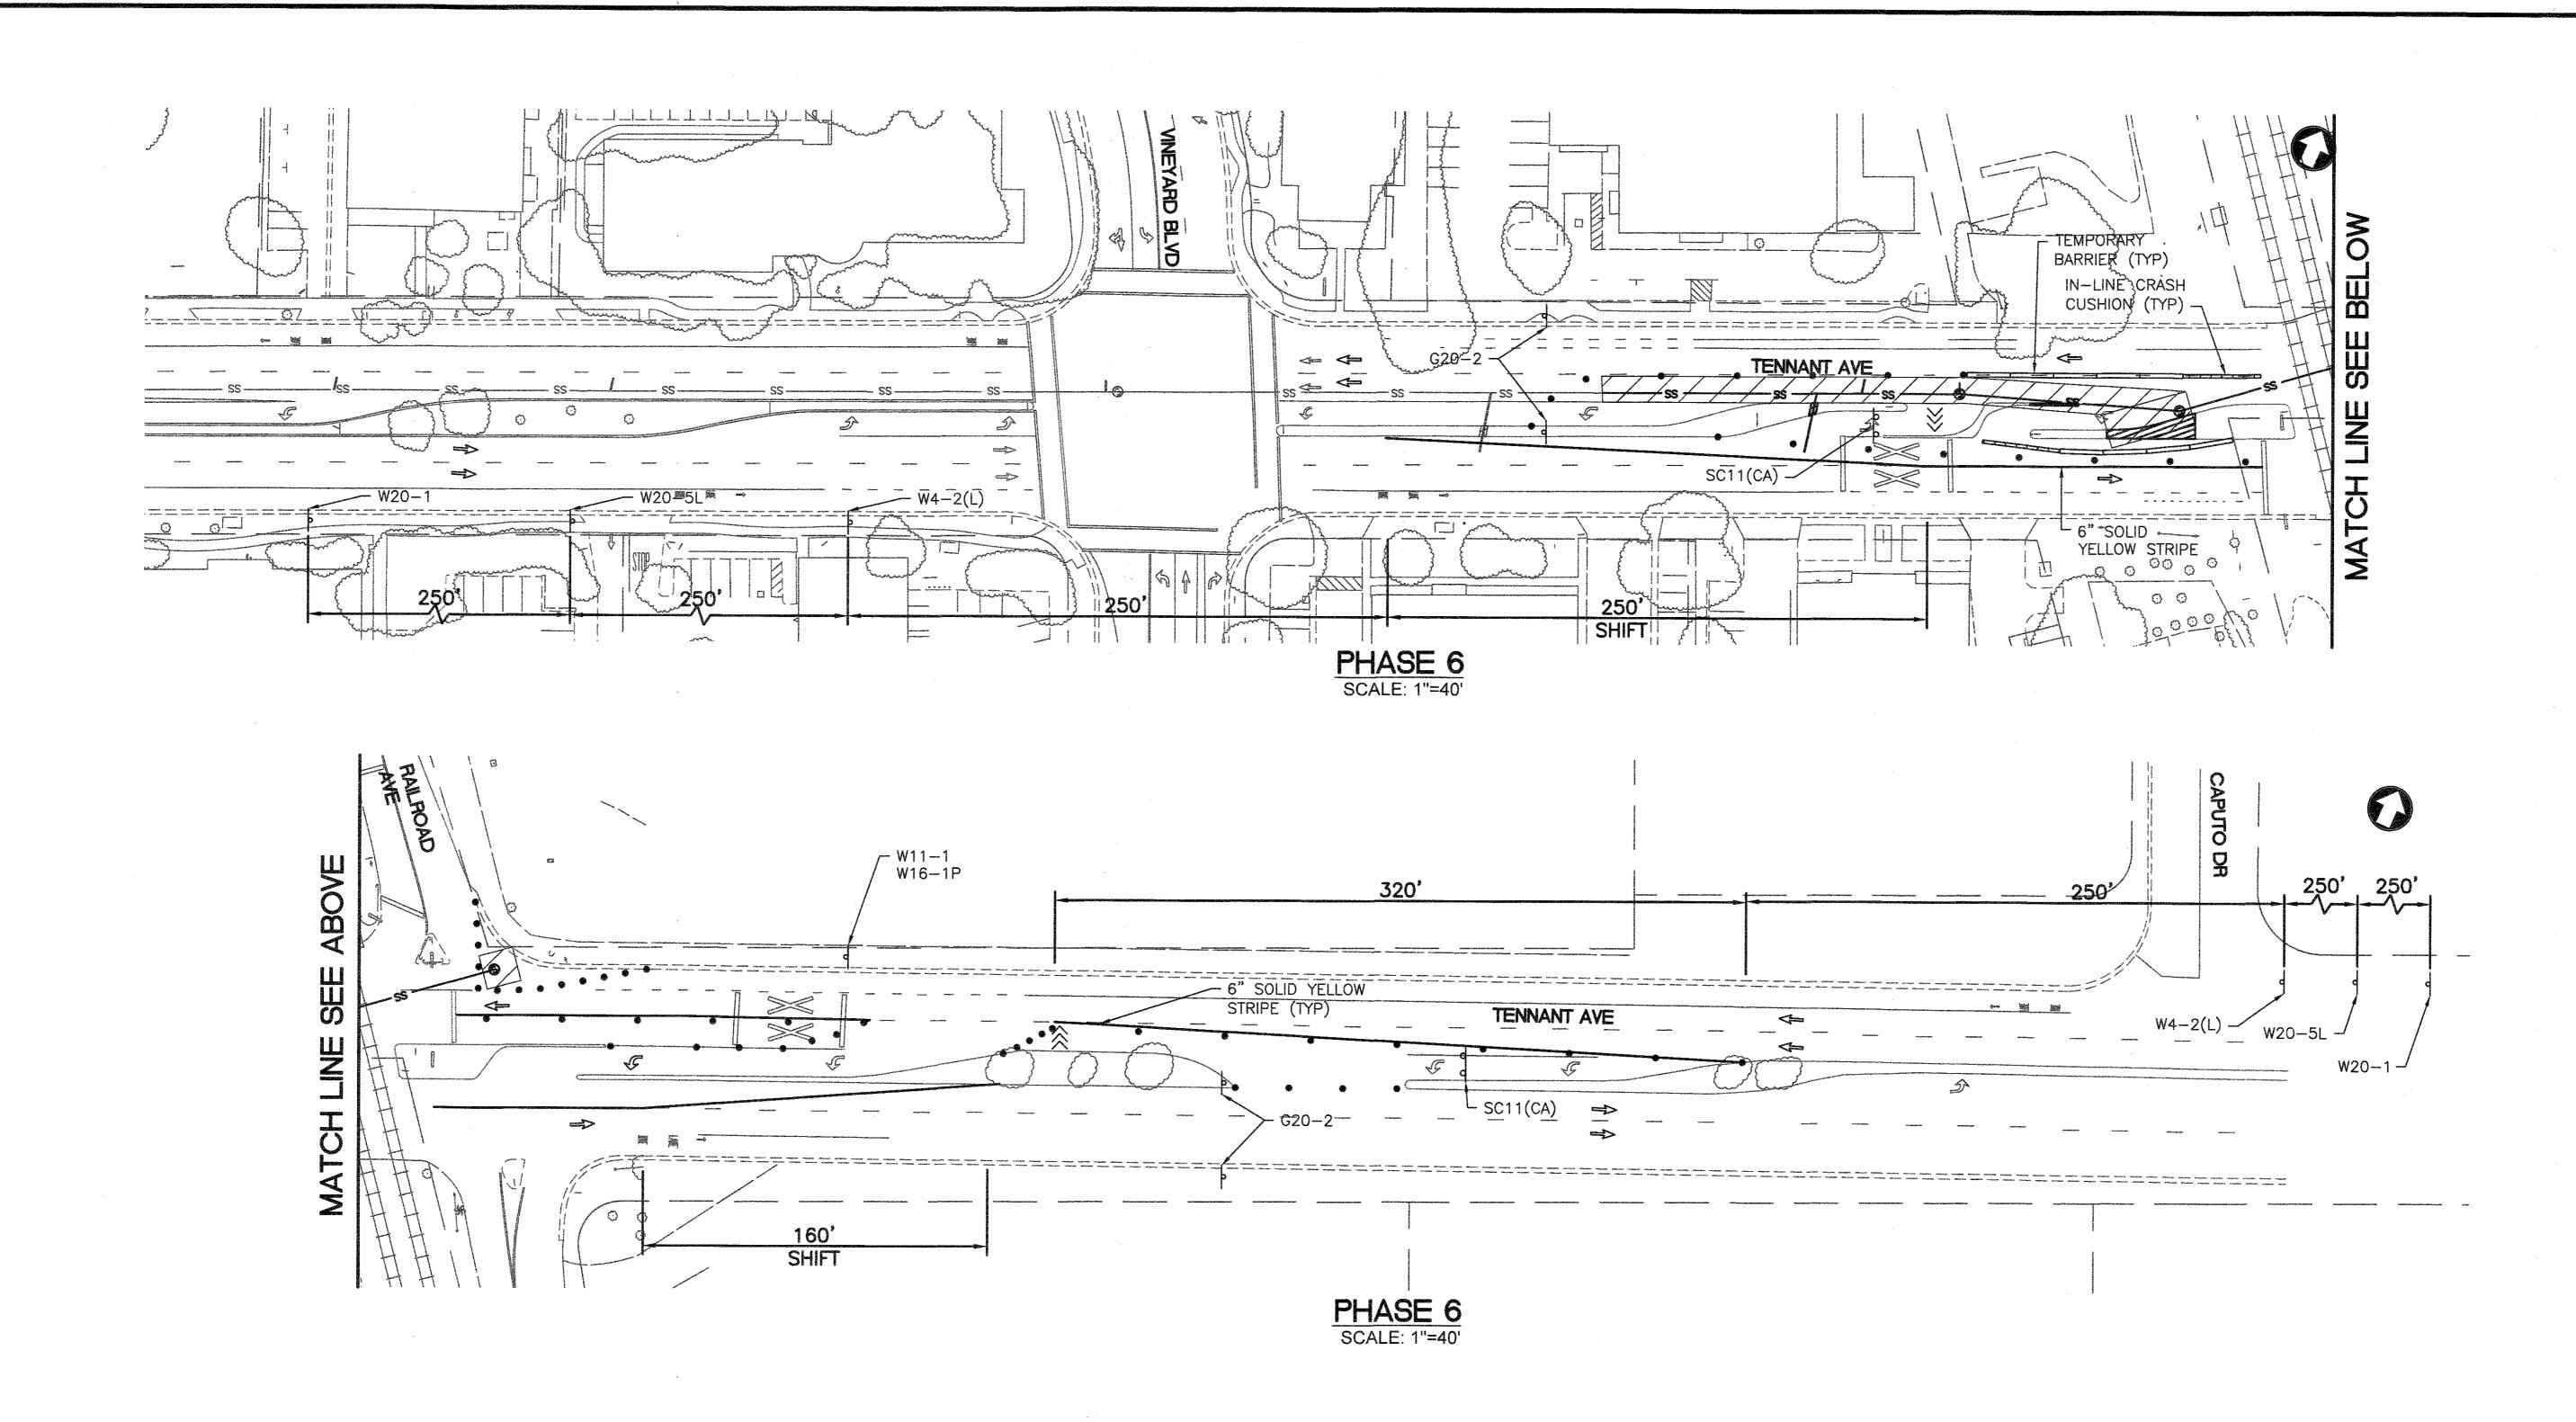

TENNANT AVE POSTED SPEED LIMIT = 40 MPH RAILROAD AVE POSTED SPEED LIMIT = 40 MPH

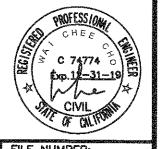

DESIGN: TC WORK ACCEPTED: INSPECTOR: 1"=40' VERT: 1"=4' MGCHECKED:

DC

APPROVED: AS-BUILT CORRECTIONS JOB NUMBER: 376483 DESCRIPTION DATE BY DATE: 5.6-Revisions CITYENGR SCOTT CREER RCE 58879 EXP. 06/30/19



City of Morgan Hill Public Works Department 100 Edes Ct. Morgan Hill, CA 95037 (408)776-7337, Fax (408)779-6282



2077 GATEWAY PLACE SUITE 550 SAN JOSE, CA 95110 WWW.MOTTMAC.COM

TRAFFIC CONTROL PLAN TENNANT AVENUE SEWER MAIN PROJECT

FILE NUMBER: 302T17 PRINT DATE: 6/5/2019 SHEET NUMBER:

